

SITE DEMOLITION PLAN GENERAL NOTES

1. REFER TO OTHER DRAWINGS FOR ADDITIONAL SITE DEMOLITION WORK AND REQUIREMENTS.
2. WHEN PARTIAL DEMOLITION IS REQUIRED, SAW CUT THE AREA SCHEDULED TO REMAIN BEFORE DEMOLITION TO PREVENT UNNECESSARY DAMAGE TO THE ADJACENT AREAS. PROTECT ALL EXISTING ITEMS NOT SCHEDULED FOR DEMOLITION FROM DAMAGE.
3. CONTRACTOR SHALL INVESTIGATE EXISTING CONDITIONS PRIOR TO STARTING WORK TO DETERMINE THE LOCATION OF LOAD BEARING WALLS AND STRUCTURAL JP EXISTING SYSTEMS/ASSEMBLIES AS REQUIRED. PROPERLY PRIOR TO REMOVING THEM, WHEN IN DOUBT, CONTACT ARCHITECT PRIOR TO REMOVING ANY ITEMS IN QUESTION.
4. PROVIDE CONSTRUCTION SIGNAGE ON FINISHED CONSTRUCTION BARRIER DURING CONSTRUCTION PHASE AS REQUIRED
5. VA REMAINS FIRST--RIGHT--REFUSAL FOR ALL DEMOLISHED ITEMS. GC PROVIDE LIST OF ITEMS TO VA COIR FOR REVIEW AND SELECTION.


SITE DEMOLITION PLAN KEY NOTES

- 1 EXISTING MODULAR BUILDING TO BE REMOVED
- 2 EXISTING CANOPY ASSEMBLY TO BE REMOVED
- 3 CASUALLY DISMANTLE AND REMOVE EXISTING ELEVATOR ASSEMBLY AND COATED COMPONENTS WITH EXISTING EXTERIOR BRICK AT ADJACENT EXTERIOR WALL TO REMAIN.
- 4 EXISTING CONCRETE RAMP, WALLS, WALK WAYS, AND HANDRAILS TO BE REMOVED.
- 5 EXISTING CANOPY AND ITS STRUCTURAL STEEL TO BE CASUALLY REMOVED AND STORED FOR REUSE OR DISPOSAL AT CONTRACTOR'S OPTION. REFER TO ASHMS FOR ADDITIONAL INFORMATION.
- 6 REMOVE EXISTING CURBS, SIDEWALKS, AND PAVEMENT AS REQUIRED TO ACCOMMODATE NEW WORK.
- 7 REMOVE EXISTING FENCING AND ALL SURFACE MOUNTED EQUIPMENT.
- 8 GC TO PROVIDE AND MAINTAIN ON-SITE PORTABLE RESTROOM FACILITIES FOR ALL LOCATION WITH VA COIR PRIOR TO DELIVERY.

SITE DEMOLITION PLAN LEGEND

- EXIST. ITEMS TO REMAIN
- EXISTING ITEMS TO BE REMOVED OR RELOCATED
- REMOVE 8'x4' GUARANING CONSTRUCTION FENCING W/ WATER & UV RESISTANT FABRIC CONSTRUCTION SCREENING IN ORDER TO MAINTAIN A SECURE CONSTRUCTION SITE. COORDINATE FINAL LAYOUT, GATE LOCATIONS, AND FENCING WITH VA COIR. SEE SPECIFICATIONS FOR ADDITIONAL INFORMATION AND REQUIREMENTS.
- TEMPORARY WEATHER RESISTANT EXTENDED CONSTRUCTION BARRIERS WITH LONG-TERM ATTACHMENTS WHERE/AS REQ'D BY VA TO FULLY ENCLOSE AREAS OF CONSTRUCTION. THE LOCATIONS & CONFIGURATIONS SHOWN ARE ONLY AN APPROXIMATION.
- TEMPORARY CONSTRUCTION BARRIER NOTE - GC WILL BE REQUIRED TO PROVIDE TEMPORARY WEATHER RESISTANT EXTENDED CONSTRUCTION BARRIERS WITH LONG-TERM ATTACHMENTS WHERE/AS REQ'D BY VA TO FULLY ENCLOSE AREAS OF CONSTRUCTION. THE LOCATIONS & CONFIGURATIONS SHOWN ARE ONLY AN APPROXIMATION.

KEY PLAN

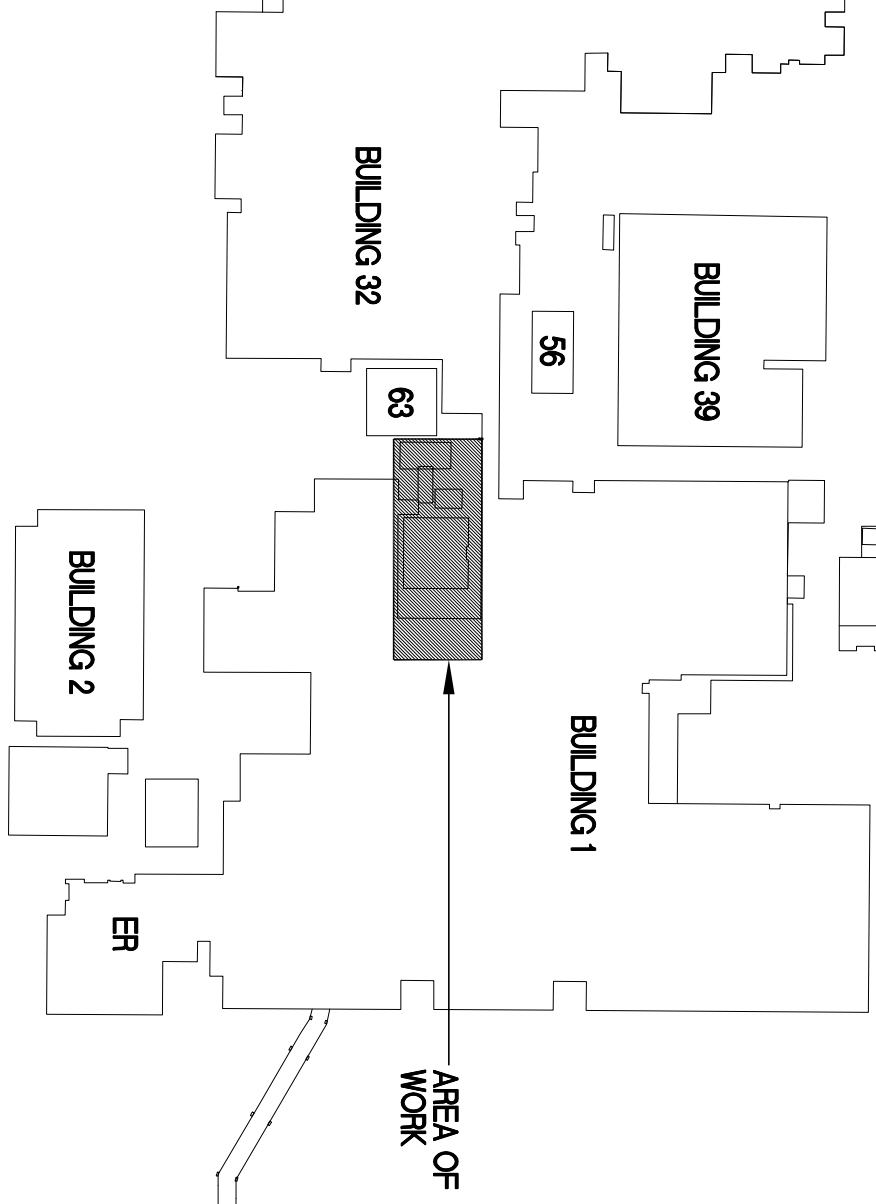

Drawing Title
SITE DEMOLITION PLAN

Project Title
SPECIALTY TREATMENT EXPANSION
PROJECT- BUILDING #1

Location
JAMES A. HALEY VETERANS' HOSPITAL

Date
02/29/11

Checked
TTV

Drawn
TAG

Dwg 1 of 40

Office of
Construction
and Facilities
Management
Department of
Veterans Affairs


04-18-12 MEDICAL EQUIPMENT AND INTERIOR DESIGN REVISIONS

ARCHITECT/ENGINEERS:




CONSULTANTS:

PERSON	DATE
657 SUBMITTAL	02/29/11
957 SUBMITTAL	03/29/11
1002 SUBMITTAL	04/13/11
CONSTRUCTION SET	05/02/11
Δ Construction to BID OTHER- ADDENDUM M	11/03/11
RELOC. EQUIPMENT AND INTERIOR DESIGN REVISIONS	04/18/12

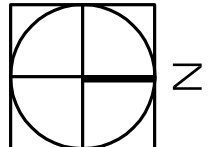

1 SITE DEMOLITION PLAN

3/16"=1'-0"

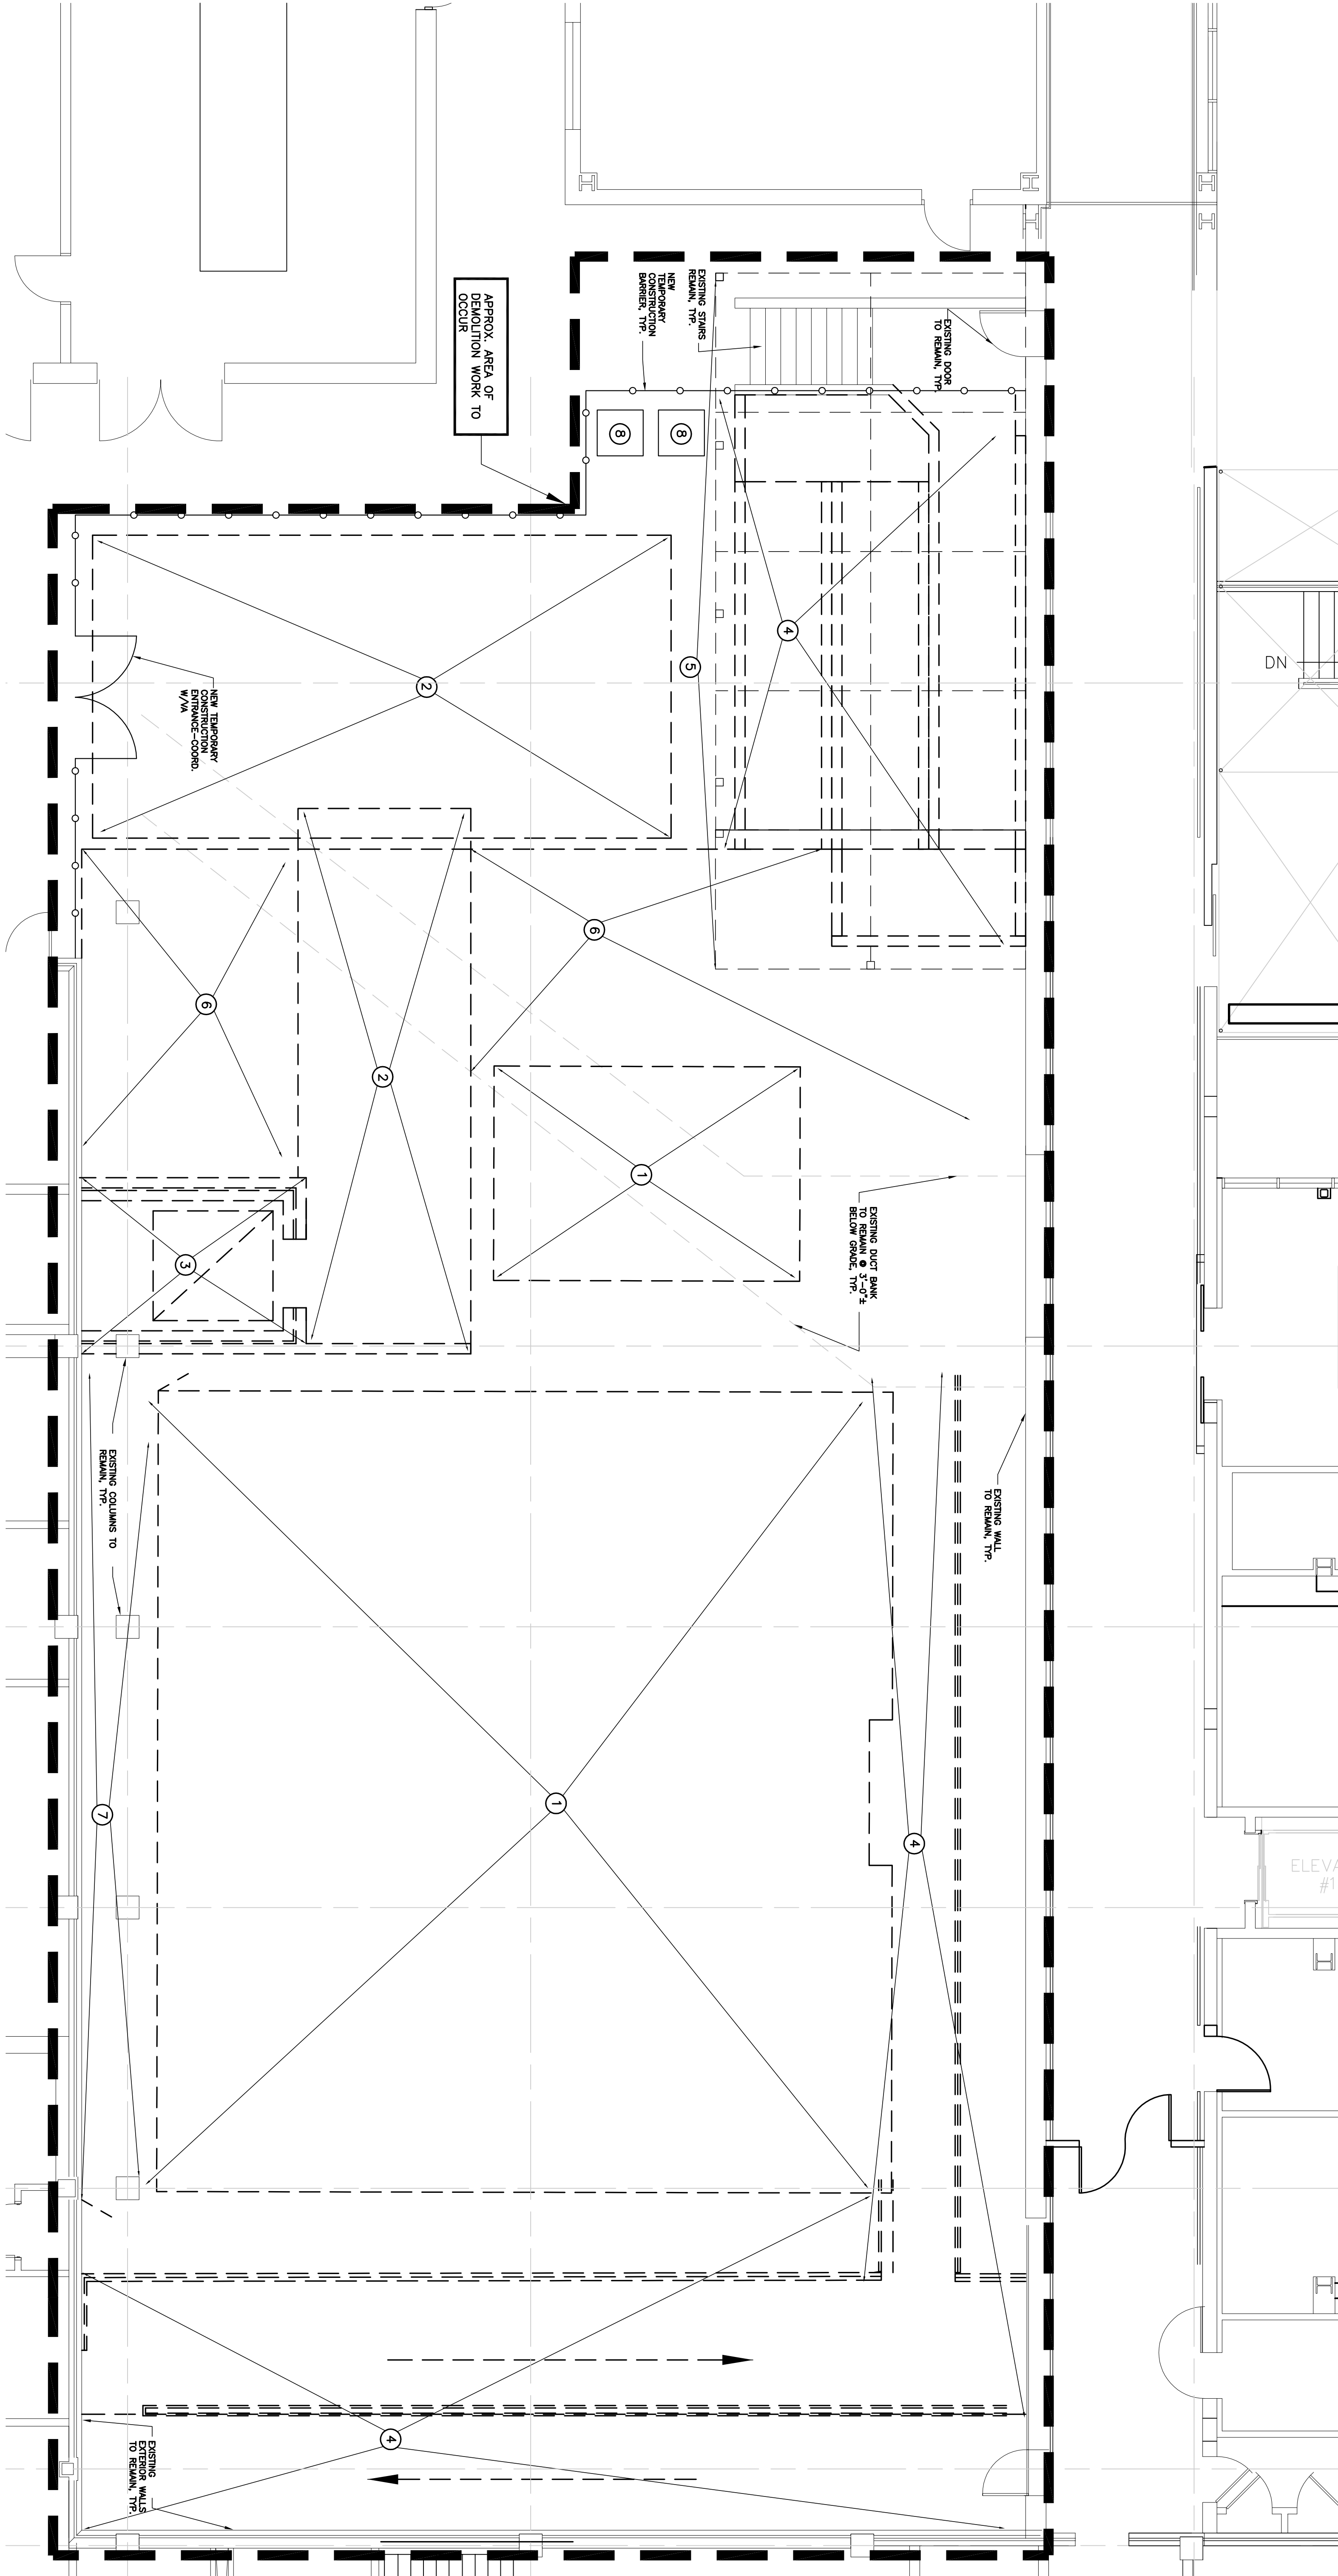

three inches = one foot

one and one half inches = one foot

one inch = one foot



three quarters inch = one foot

one half inch = one foot

three eighths inch = one foot

one quarter inch = one foot

one eighth inch = one foot

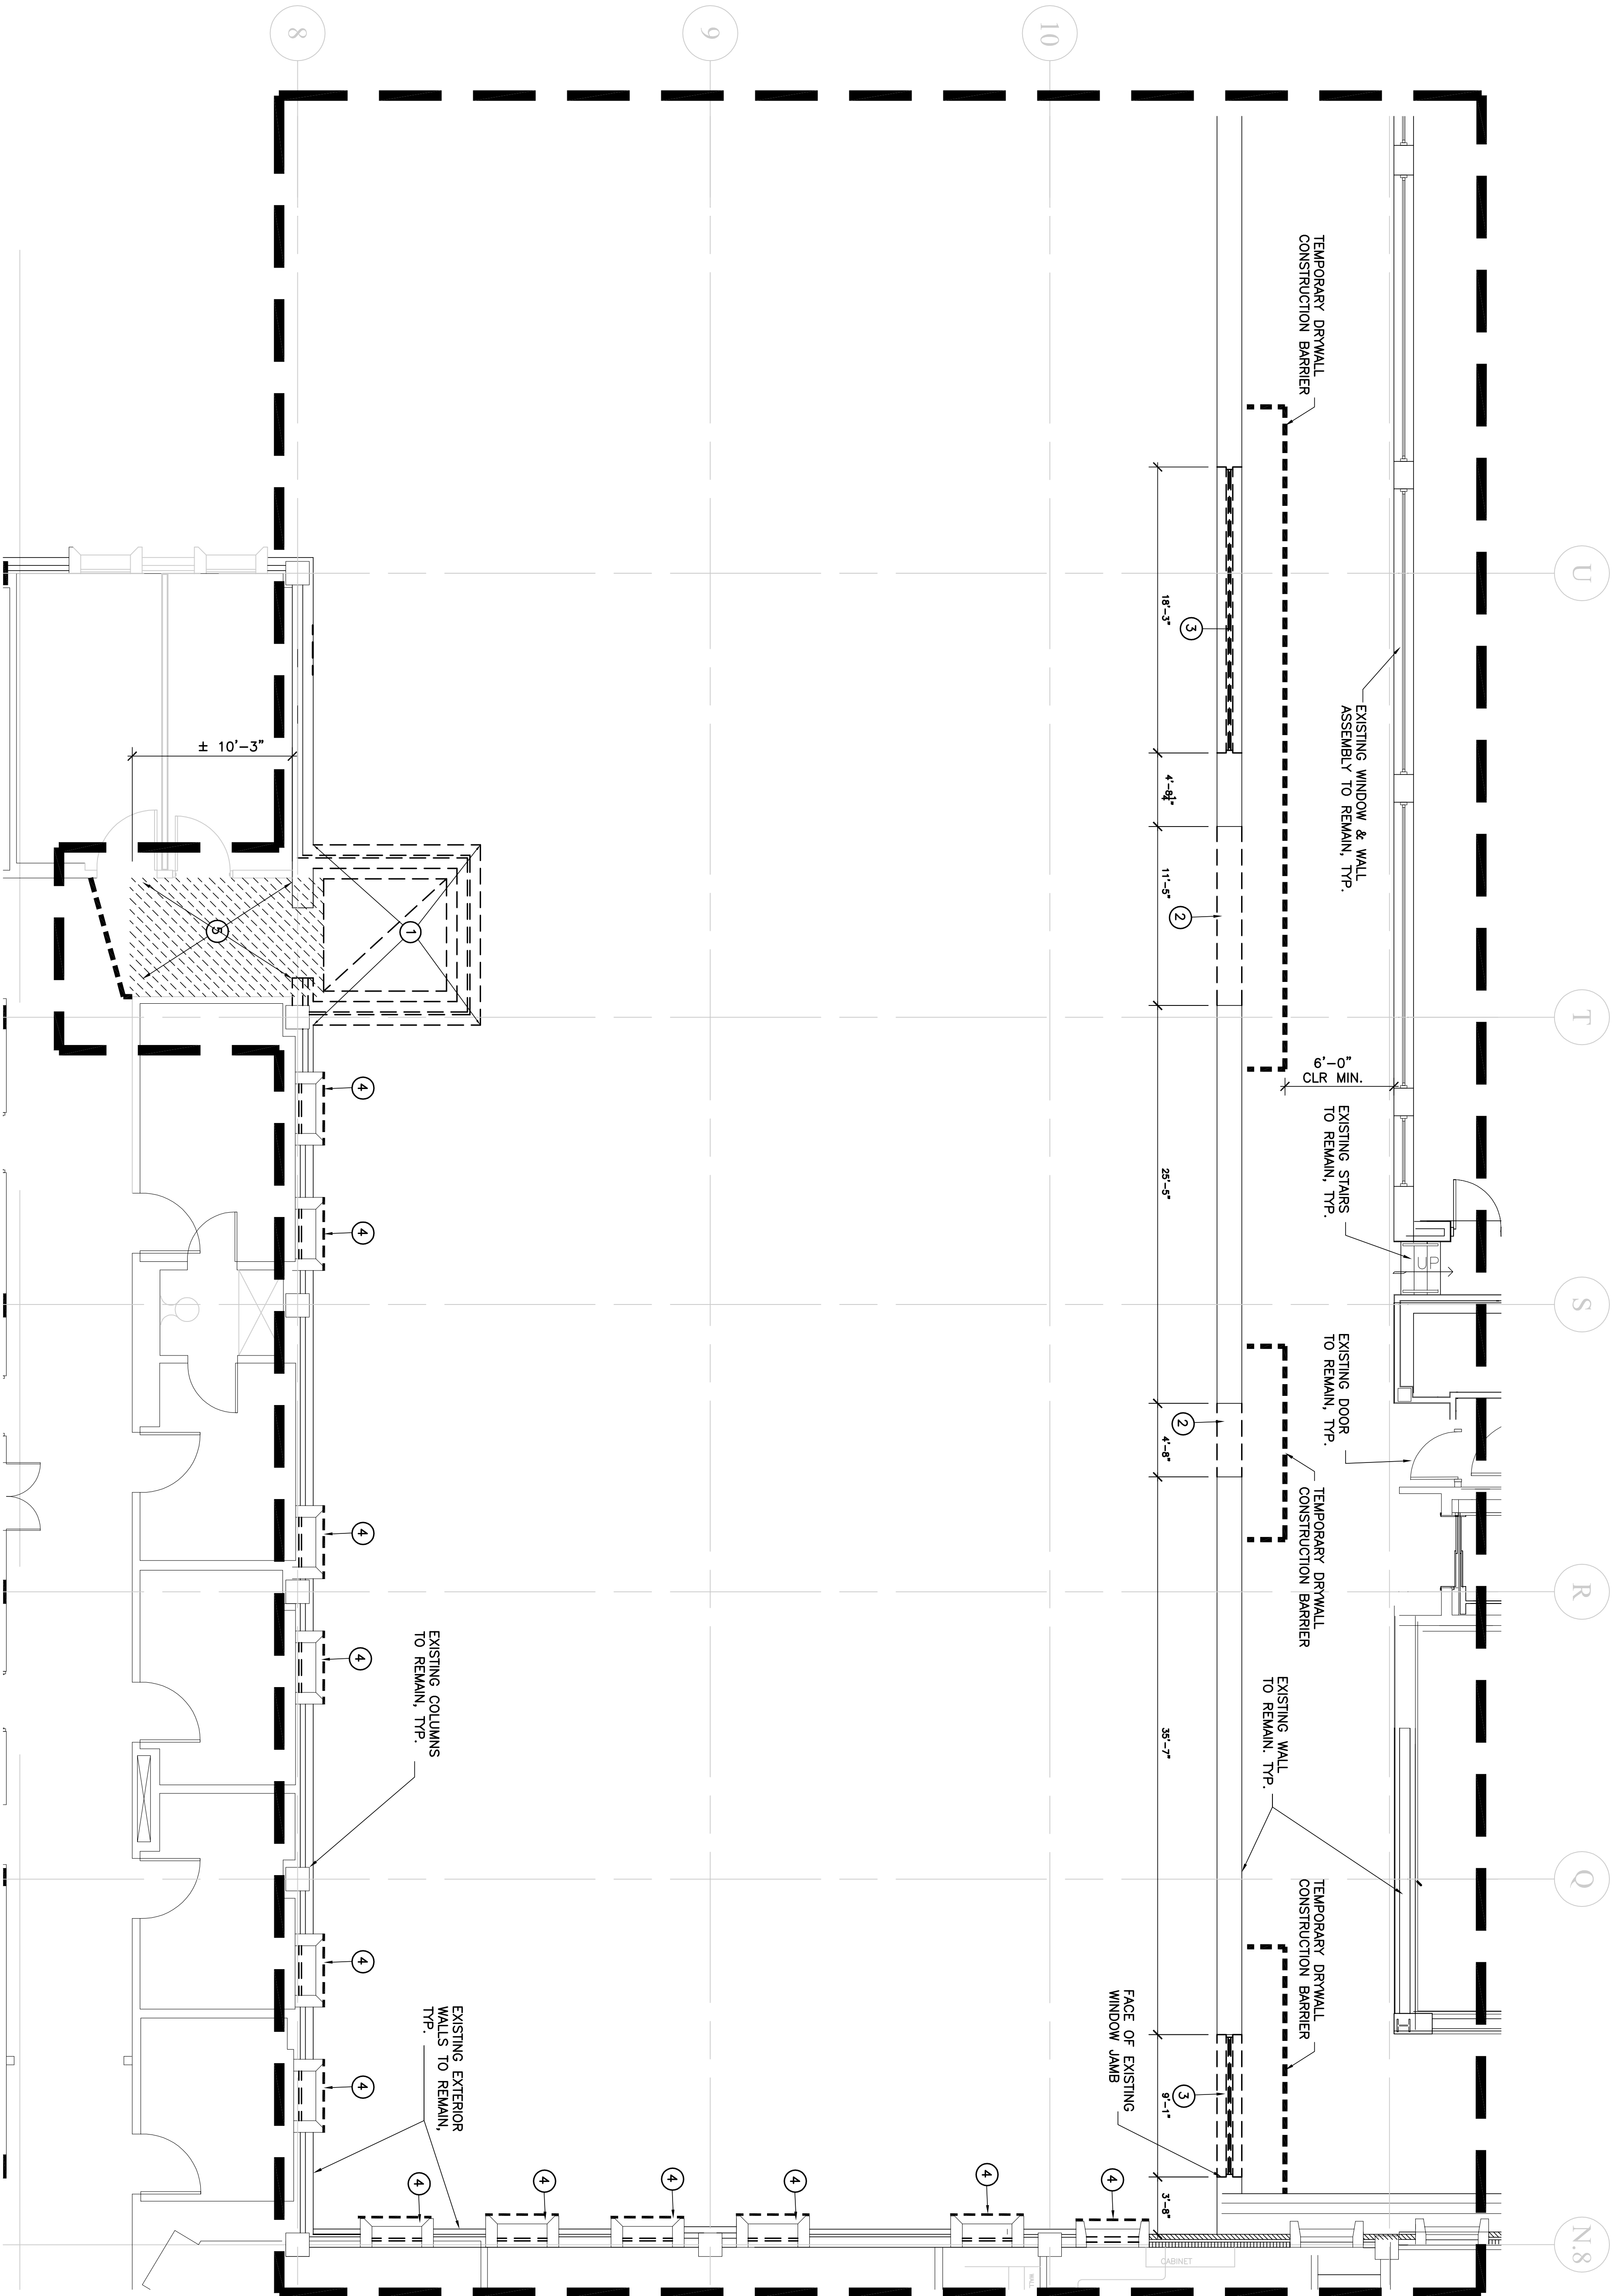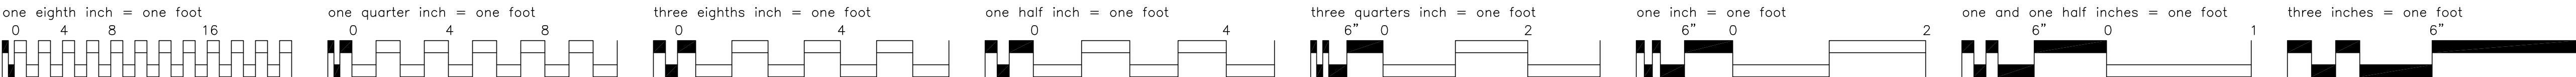

1 FIRST FLOOR DEMOLITION PLAN
3/16=1'-0"

GENERAL ASBESTOS NOTE

THE AREA OF CONSTRUCTION HAS ASBESTOS CONTAINING MATERIALS THAT WILL NEED TO BE ABATED AS PART OF THE GC'S SCOPE OF WORK. REFER TO SPECIFICATIONS FOR SPECIFIC REQUIREMENTS AND ASBESTOS RELATED INFORMATION.

REVISION	DATE
REV SUBMITTAL	02/19/11
REV SUBMITTAL	02/29/11
REV SUBMITTAL	04/03/11
CONSTRUCTION SET	09/02/11
1. Corrections to Bid Options - ADDENDUM #4	11/09/11
MEDICAL EQUIPMENT AND INTERIOR DESIGN REVISIONS	04/18/12

CONSULTANTS:

ARCHITECT/ENGINEERS:



04-18-12 MEDICAL EQUIPMENT AND INTERIOR DESIGN REVISIONS

DEMOLITION PLAN GENERAL NOTES

1. REFER TO OTHER DRAWINGS FOR ADDITIONAL DEMOLITION WORK AND REQUIREMENTS.
2. THE CONTRACTOR IS RESPONSIBLE FOR PROVIDING CLEAN SMOOTH WALL, FLOOR, AND CEILING SURFACES.
3. GC TO INSTALL ALL ENVIRONMENTAL CONTROLS SPECIFIED HEREIN PRIOR TO COMMENCING WITH DEMOLITION.
4. ALL SMOKE DETECTORS WITHIN CONSTRUCTION SHALL BE REPLACED WITH HEAT DETECTORS
5. PROVIDE CONSTRUCTION SIGNAGES ON FINISHED CONSTRUCTION BARRIER DURING CONSTRUCTION PHASE AS REQUIRED
6. PROVIDE FOOT PRE WASH STATION FOR ALL PERSONS LEAVING THE INTERIOR CONSTRUCTION AREA. SEE SPEC SECTION 10 00 00 FOR SYSTEM REQUIREMENTS.
7. REPAIR OR REPLACE ANY EXISTING ITEM SCHEDULED TO REMAIN EXISTING DAMAGED DURING CONSTRUCTION AS REQ'D. TO MATCH EXISTING UNLESS OTHERWISE NOTED
8. ONE OFF ANY UNLINED PIPING OR CONDUNTS AS REQUIRED.
9. GC TO COORDINATE ALL WORK WITH ASBESTOS ABATEMENT SCOPE OF WORK-REFER TO DRAWINGS & SPECIFICATIONS.
10. DEMOLITION WORK SHALL BE AS REQUIRED TO ACHIEVE A CLEAN SMOOTH, AND PLUMB NEW WORK. FOR EXAMPLE IT IS REQUIRED THAT ITEMS SUCH AS EXISTING SPOKES ON WALLS TO BE REMOVED PRIOR TO DEMOLITION OF THE WALLS.
11. THE EXISTING THERMOSTAT IF NOT SCHEDULED TO BE REUSED, THE EXISTING THERMOSTAT SHALL BE REMOVED PRIOR TO DEMOLITION OF THE WALLS OR NOT.
12. WHEN PARTIAL DEMOLITION IS MADE TO EXISTING WALL OR FLOOR, CONTRACTOR SHALL INVESTIGATE EXISTING CONDITIONS PRIOR TO WALLS AND STRUCTURAL COLUMNS. WHEN SUCH ITEMS ARE IDENTIFIED, CONTRACTOR SHALL REMOVE THEM PRIOR TO DEMOLITION. WHEN IN DOUBT, CONTACT ARCHITECT PRIOR TO REMOVING ANY ITEMS IN QUESTION.
13. HAIL AWAY ALL DEBRIS PROMPTLY
14. GC TO PROVIDE HARD COVER CARDS WITH HARD COVER SEALED CONSTRUCTION AREA. ALL DEBRIS CARDS SHALL HAVE HARD PLOSTIC COVER.
15. PROVIDE THE PORTABLE POP UP BOOTH FOR WORK OUTSIDE OF CONSTRUCTION AREA. REFER TO THE SPECIFICATION SECTION 01 00 00 FOR ADDITIONAL INFORMATION
16. CONTRACTOR SHALL EXHAUST NEGATIVE PRESSURE FILTRATION LOCATED ALONG THE PERIMETER OF THE WORK AREAS. THESE LOCATIONS FOR THE DURATION OF THE PROJECT (SEE DRAWING) SHALL BE MAINTAINED THROUGHOUT THE PROJECT. EXHAUST LOCATION AND TEMPORARILY REPLACE WITH PLYWOOD BARRIER WITH WATERPROOF PAINT COATING AND CALL ALL ASSEMBLY CONTRACTOR SHALL REINSTALL ORIGINAL WINDOW ASSEMBLIES IN A WATERRIGHT CONDITION TO MATCH EXISTING CONDITIONS
17. CONTRACTOR SHALL BE RESPONSIBLE FOR REMOVING DAMAGED TO EXISTING WINDOW ASSEMBLIES AND SHALL COORDINATE WINDOW REMOVAL, BUILDING ENVELOPE PROTECTION MEASURES AND WEATHER STRIPPING WITH THE VA CORP. REFER TO 3/AD102
18. CONTRACTOR SHALL COORDINATE WITH VA CORP FOR WORK TIME SCHEDULED TO NOT INTERFERE WITH EXISTING OPERATIONS.
19. THE FLOOR WILL BE OCCUPIED DURING CONSTRUCTION. CONSTRUCTION MUST BE PHASED AS TO NOT SHUT DOWN UTILITIES AND INFRASTRUCTURE (I.E. WATER, POWER, DATA, TELEPHONES, ETC.) AS REQUIRED TO MAINTAIN DAILY, UNINTERRUPTED OPERATIONS.
20. PHASE WORK IN THE RPL CORRIDOR AS REQUIRED TO MAINTAIN THE PUBLIC ACCESS WIDTH TO LESS THAN 6'-0" WIDE MUST BE SCHEDULED IN ADVANCE WITH THE VA CORP AND BE DONE AFTERNOONS AT NO ADDITIONAL COST TO THE GOVERNMENT.
21. ALL WORK REQUIRING THE USE OF TOOLS THAT WILL PRODUCE AN OBJECTABLE AMOUNT OF NOISE, FUMES, OR DUST BEYOND A NEW CONSTRUCTION SHALL BE SCHEDULED AND COORDINATED WITH VA PROJECT MANAGER PRIOR TO COMMENCING SAID WORK. BE MADE IF CONTRACTOR IS STOPPED DUE TO WORK BEING CONDUCTED BY CONTRACTOR DUE TO OBJECTABLE NOISE, FUMES, OR DUST.
22. ALL WORK WILL BE SUBJECT TO RE-SCHEDULING IF SO REQUESTED BY THE VA CORP AND MAY OCCUR AT VA DISCRETION.


DEMOLITION PLAN KEY NOTES

1. CAREFULLY DEMOLISH AND REMOVE EXISTING ELEVATOR ASSEMBLY AND ASSOCIATED COMPONENTS. DEMOLISH SHAFT, WALL ASSEMBLY, AND ASSOCIATED REMAIN. - SEE OTHER DRAWINGS, TYP.
2. GC TO REMOVE PORTION OF EXISTING WALL AND ANY ASSOCIATED WALL MOUNTED EQUIPMENT
3. GC TO CAREFULLY REMOVE EXISTING WINDOW ASSEMBLY. STORE FOR REUSE OR TURN OVER TO VA
4. GC TO PROVIDE 3/4" OX PLYWOOD FULL HEIGHT WEATHER RESISTANT TEMPORARY CONSTRUCTION BARRIER TO PROTECT EXISTING WINDOWS, TYP DURING FRAME INFILL FROM EXISTING WINDOW ASSEMBLY. CONCRETE FRAME IS TO REMAIN AND BE PREP'D TO RECEIVE NEW INFILL
5. GC TO DEMO PORTION OF EXISTING CEILING, FIREPROOFING, AND FLOOR TILE IN AREA HATCHED. COORDINATE WORK WITH ASBESTOS ABATEMENT WORK.
6. GC TO REMOVE EXIST DOOR AND FRAME.









DEMOLITION PLAN LEGEND

- EXIST. ITEMS TO REMAIN
 - EXISTING ITEMS TO BE REMOVED OR RELOCATED
 - NEW DUST-PROOF, SMOKE TIGHT, ONE-HOUR AND/OR 2-HOUR FIRE RATED TEMPORARY CONSTRUCTION BARRIER, SEE 2/AD102 FOR SPECIFICATIONS FOR ADDITIONAL INFORMATION AND REQUIREMENTS.
 - AREA OF EXISTING FLOOR AND/OR CEILING TO BE REMOVED & REPLACED
 - EXIST. 2-HOUR FIRE RATED CONSTRUCTION, TYP.
- TEMPORARY DEMOLITION CONSTRUCTION BARRIER NOTE - GC WILL BE REQUIRED TO PROVIDE TEMPORARY CONSTRUCTION BARRIERS WITH ONE-TIME CONSTRUCTION, TYP. THE LOCATIONS & CONFIGURATIONS SHOWN ARE ONLY AN APPROXIMATION.


KEY PLAN

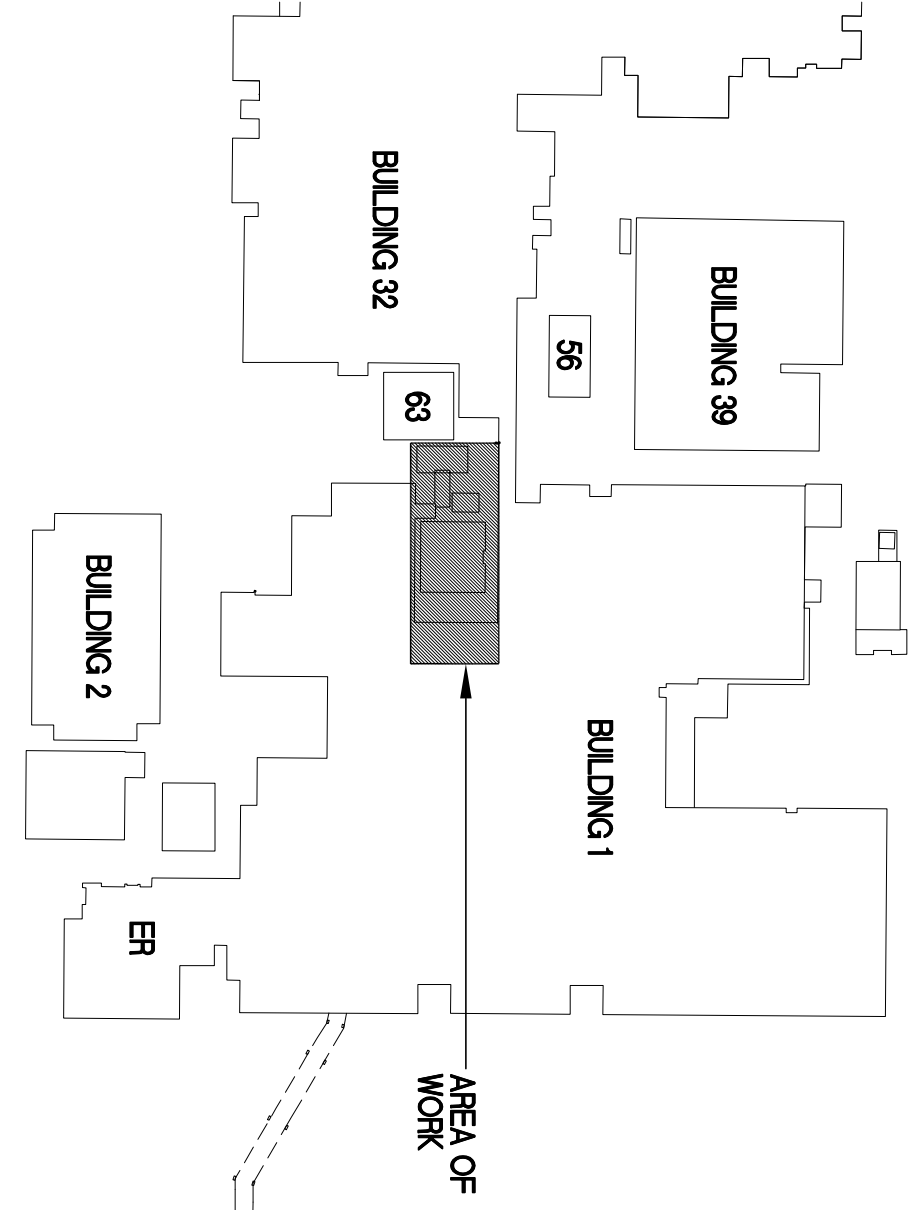


Project Title	Project Title	Project Number	Office of Construction and Facilities Management
FIRST FLOOR DEMOLITION PLAN	SPECIALTY TREATMENT EXPANSION PROJECT - BUILDING #1	673-CS-100	
Approved Project Director	Location	Building Number	
	JAMES A. HALEY VETERANS HOSPITAL	1	
Date	Checked	Drawn	
02/19/11	TTY	TAG	
		Dwg 3 of 40	

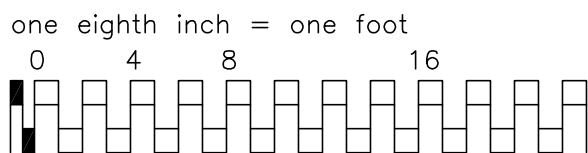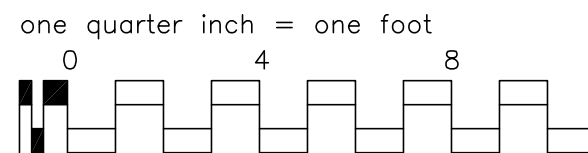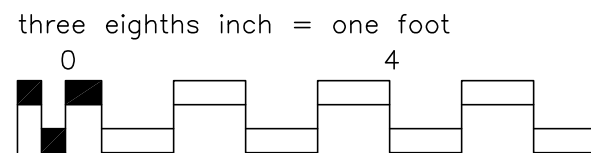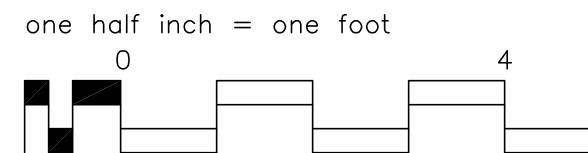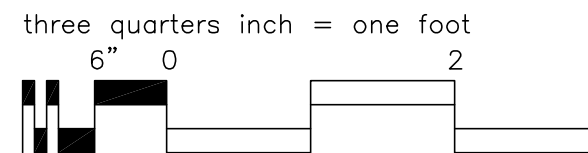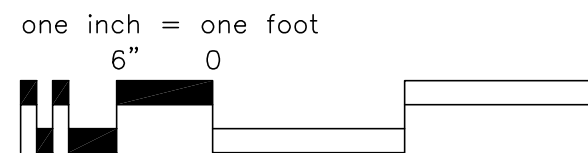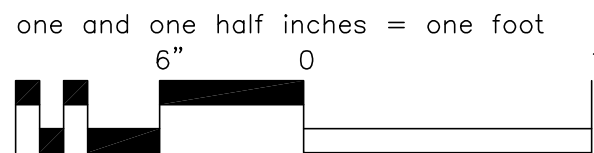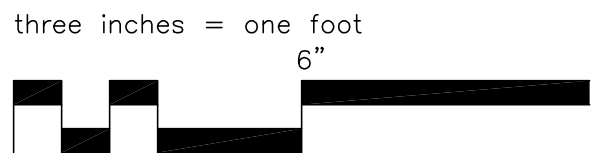

REGION	DATE
657.5B/NTL	02/09/11
657.5B/NTL	03/29/11
607.5B/NTL	04/03/11
COMMENTS/RESETH COMMENTS	05/02/11
Δ Certification to B6 Options- ADDENDUM 14	11/09/11
MEDICAL EQUIPMENT AND INTERIOR DESIGN REVISIONS	04/01/12

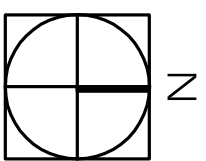

NEW FIRST FLOOR PLAN

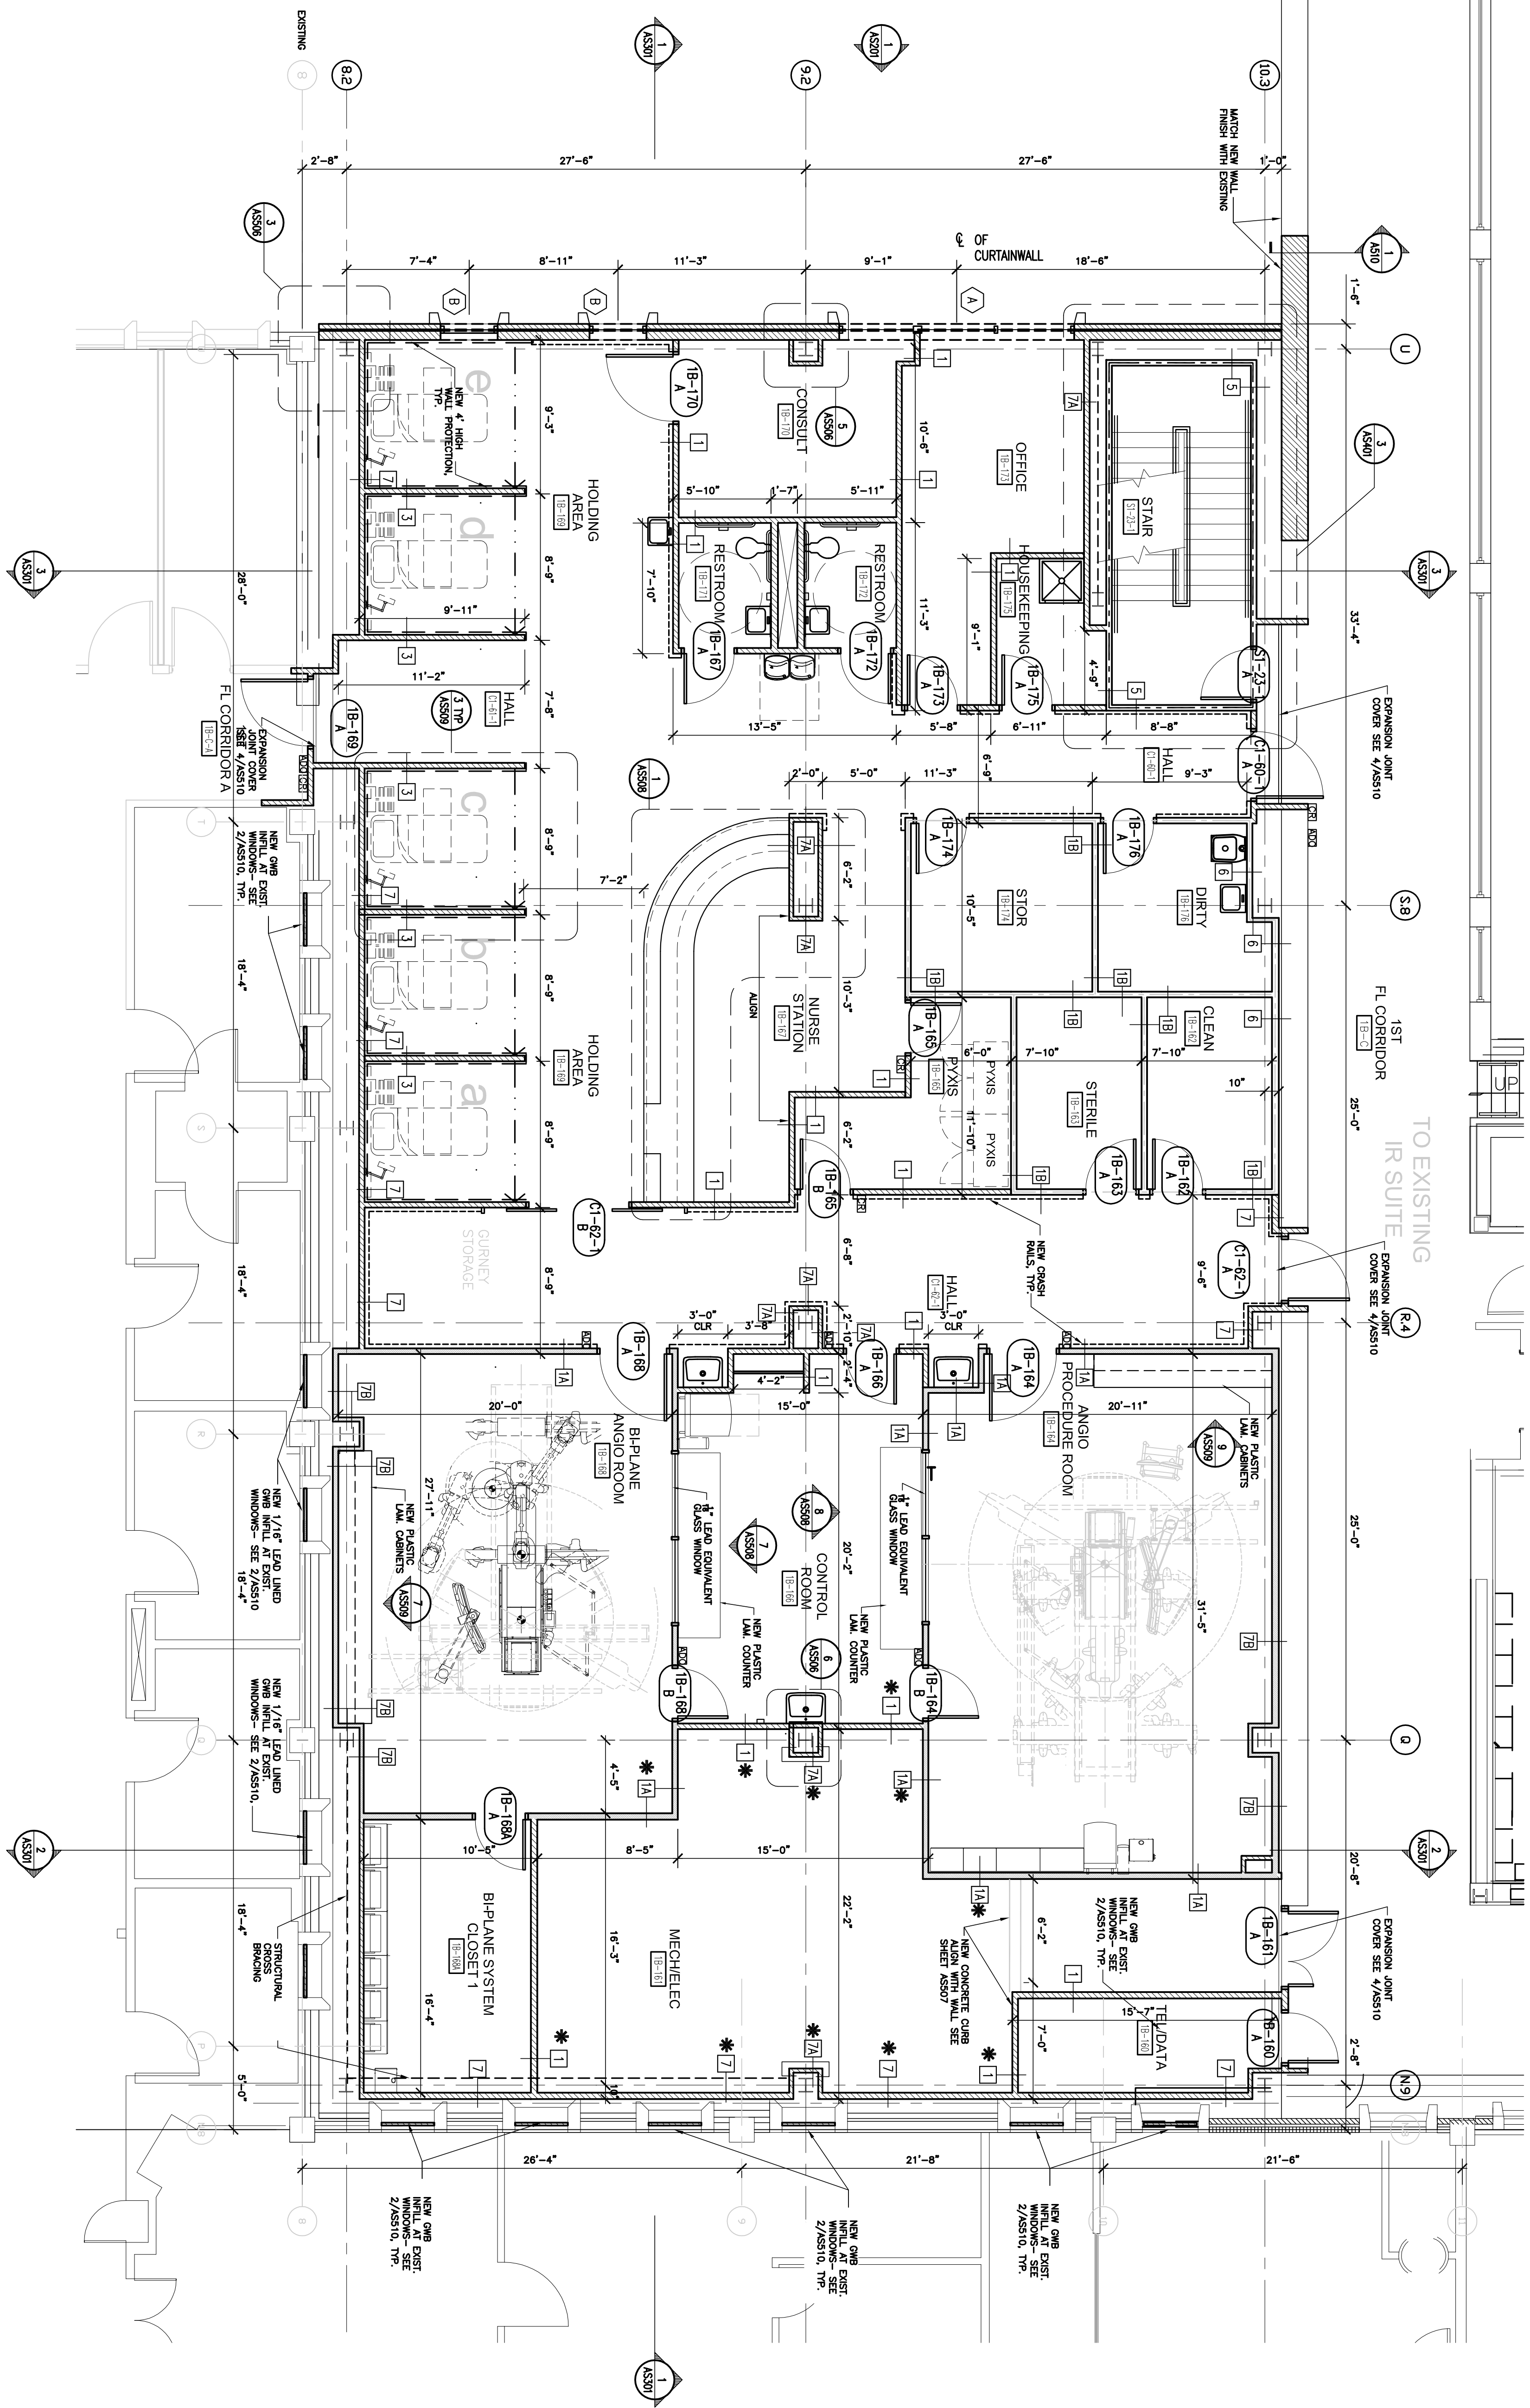

04-18-12 MEDICAL EQUIPMENT AND INTERIOR DESIGN REVISIONSS

NOTE- COORD. ALL DIMENSIONS W/ VA EQUIPMENT
NOTE- SEE EQUIPMENT PLAN FOR MORE INFORMATION
- REFER TO ENLARGED PLANS FOR MORE DETAILS

Drawing Title
NEW FIRST FLOOR PLAN

Project Title SPECIALTY TREATMENT EXPANSION PROJECT - BUILDING #1	Project Number 673-CSH-100
Location JAMES A. HALEY VETERANS' HOSPITAL	Drawing Number AST02
Date 02/8/11	Sheet Number 1
Checked TTY	Dwg 6 of 40
Drawn TAG	

**Office of
Construction
and Facilities
Management**











NEW FLOOR PLAN GENERAL NOTES

1. THE CONTRACTOR IS RESPONSIBLE FOR PROVIDING CLEAN SMOOTH WALL, FLOOR AND CEILING SURFACES.
2. CONTRACTOR SHALL BE RESPONSIBLE FOR EXTENDING ANY ITEMS SUCH AS OUTLETS, SWITCHES, ETC. TO THE NEW SURFACE.
3. REPAIR OR REPLACE ANY EXISTING ITEMS SCHEDULED TO REMAIN THAT ARE DAMAGED DURING CONSTRUCTION AS REQUIRED TO MATCH EXISTING.
4. ALL PENETRATION THROUGH EXISTING FINE RATED WALLS AND FLOORS MUST BE SEALED WITH AN UL APPROVED FIRESTOPPING OR FIRESTOPPING MATERIAL OR GASKETING TO MAINTAIN THE FIRE RATED CONDITION AND AS DESIGNATED BY APPLICABLE CODES- EXISTING FLOORS - 2" MIN FINE RAISED UTILITY VERIFIED BY GC OTHERWISE FINE RATED WALLS - 2" MIN FINE PENETRATIONS VERIFIED BY GC OTHERWISE.
5. GC TO CONSTRUCT / RE-SEAL ALL PENETRATIONS THROUGH EXISTING WALLS, FLOORS, AND CEILING, ETC.
6. GC TO COORDINATE WORK WITH ALL OTHERS' RELATED CONTRACTORS REGARDING THE PRESENCE AND REMOVAL OF EXISTING ASBESTOS (REFER TO SPECIFICATIONS).
7. CONTRACTOR SHALL MAINTAIN EXISTING CONDITIONS PRIOR TO STARTING WORK TO DETERMINE THE LOCATION OF ALL EXISTING UTILITIES AND STRUCTURAL STEELING COLUMNS, WHEN SUCH ITEMS ARE SCHEDULED TO BE DEMOLISHED, SHORE UP EXISTING STRUCTURE, AND PROVIDE PROTECTIVE MEASURES PRIOR TO REMOVAL OF ITEMS IN ORDER, CONTRACTOR REQUESTED PRIOR TO REMOVING ANY ITEMS IN EXISTING.
8. CONTRACTOR SHALL COORDINATE WITH VA PROJECT MANAGER FOR WORK THAT SCHEDULED TO NOT INTERFERE WITH EXISTING OPERATIONS.
9. THE FLOORS WILL BE OCCUPIED DURING CONSTRUCTION, CONSTRUCTION MUST BE PHASED AS TO NOT SHUT DOWN UTILITIES AND INFRASTRUCTURE (I.E. WATER, POWER, DATA, TELEPHONES, ETC.), AS REQUIRED TO MAINTAIN DAILY, UNINTERRUPTED OPERATIONS.
10. ALL WORK REQUIRING THE USE OF TOOLS THAT WILL PRODUCE AN OBJECTABLE AMOUNT OF NOISE, DUSTS, OR OTHER AIRBORNE PARTICULATE, AND/OR VIBRATION, SHALL BE COORDINATED WITH VA PROJECT MANAGER PRIOR TO COMMENCING SUCH WORK, NO CONTRACT INCREASES ALLOWING IN NAME OF NOISE SHALL BE MADE IF WORK IS CONDUCTED TO OBJECTABLE NOISE, DUSTS, OR OTHER AIRBORNE PARTICULATE BY CONTRACTOR DUE TO OBJECTABLE NOISE, DUSTS, OR OTHER AIRBORNE PARTICULATE.
11. ALL WORK WILL BE SUBJECT TO RE-SCHEDULING IF SO REQUESTED BY THE VA PROJECT MANAGER AND MAY OCCUR AT VA DISCRETION.
12. ALL WORKING TO BE PERFORMED WITHIN THE VA FACILITY TO BE REMOVED ALL BACKING AS REQUIRED TO ROBBY WITHIN ALL NEW WALL, MOUNTED ITEMS & ITEMS REQUIRING FASTENING TO THE WALLS.


GENERAL DIMENSION NOTE


DIMENSIONS SHOWN ON THIS SHEET ARE ALL CRITICAL DIMENSIONS THAT MUST BE HELD EXACTLY AS SHOWN IN ORDER TO ACCOMMODATE OWNER PROVIDED MEDICAL EQUIPMENT WITH EXTREMELY STRICT TOLERANCES. GO TO NOTICE ARCHITECT IMMEDIATELY IF ANY OF THE INDICATED DIMENSIONS DO NOT APPEAR TO WORK WITH THE EXISTING CONDITIONS OR OTHER DISCREPANCIES OCCUR. TYPICAL VERIFICATION IF ACTUAL EQUIPMENT ARE DIFFERENT THAN WHAT ARE SHOWN HERE.

NEW FLOOR PLAN LEGEND

	EXISTING STRUCTURAL GROUTLINE	NEW CRACKS
	NEW STRUCTURAL GROUTLINE	NEW 4" HIGH PROTECTION
	EXIST. TRAILS TO REMAIN	NEW AUTOMATIC DOOR OPERATOR
	NEW WALLS	NEW WALLS
	NEW PATIENT LIFT AND TRACK SYSTEM	NEW TIES - SEE DRAWING
	NEW ACCESS CONTROL DEVICE	PROVIDE IN CURB WITH SCHEDULED SEE ASST
	WALL WITH 1/16" LEAD SHEETING TO A HEIGHT OF 7'-0" AFF	WINDOW TYPES
	NEW 1-HOUR FIRE RATED PARTITION - SEE OTHER DRAWING	
	NEW 2-HOUR FIRE RATED PARTITION - SEE OTHER DRAWING	
		

KEY PLAN

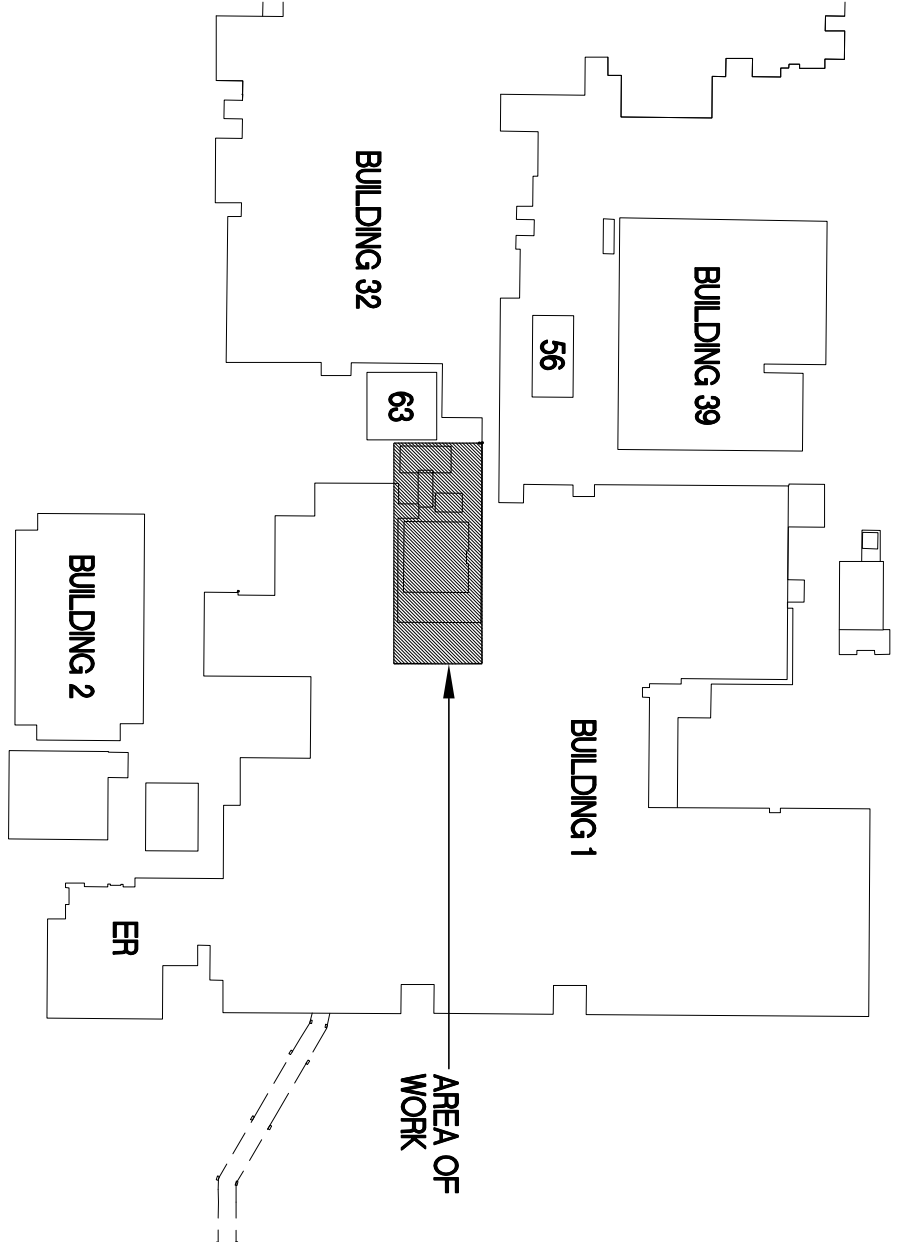

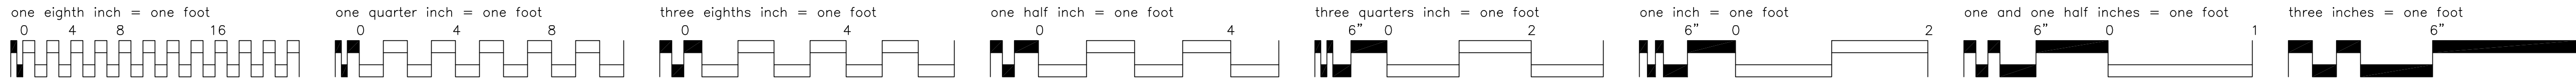

REVISION	DATE
661 SUBMITTAL	02/19/11
662 SUBMITTAL	03/29/11
663 SUBMITTAL	04/03/11
CONSTRUCTION SET	09/02/11
Contributions to Bid Options - ADDENDUM #4	11/09/11
MEDICAL EQUIPMENT AND INTERIOR DESIGN REVISIONS	04/18/12


CONSULTANTS:

ARCHITECT/ENGINEERS:


04-18-12 MEDICAL EQUIPMENT AND INTERIOR DESIGN REVISIONS

Drawing Title		Project Title		Project Number		Office of Construction and Facilities Management	
NEW SECOND FLOOR PLAN		SPECIALTY TREATMENT EXPANSION PROJECT- BUILDING #1		673-CS-100		1	
Approved Project Director		Location		Building Number		Drawing Number	
		JAMES A. HALEY VETERANS HOSPITAL		1		AS103	
Date		02/9/11		Checked		Drawn	
				TTV		TAG	
						Dwg 7 of 40	

KEY PLAN

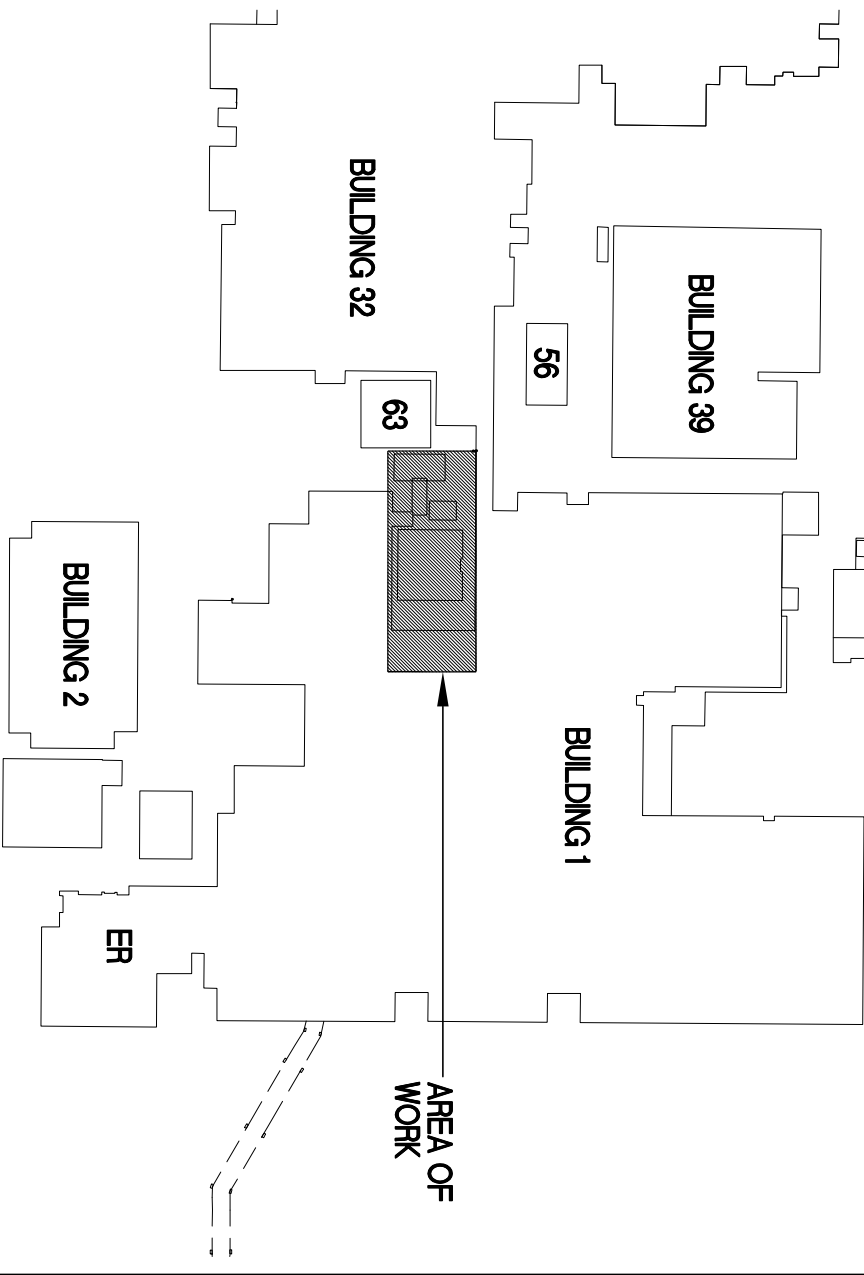

NEW SECOND FLOOR PLAN

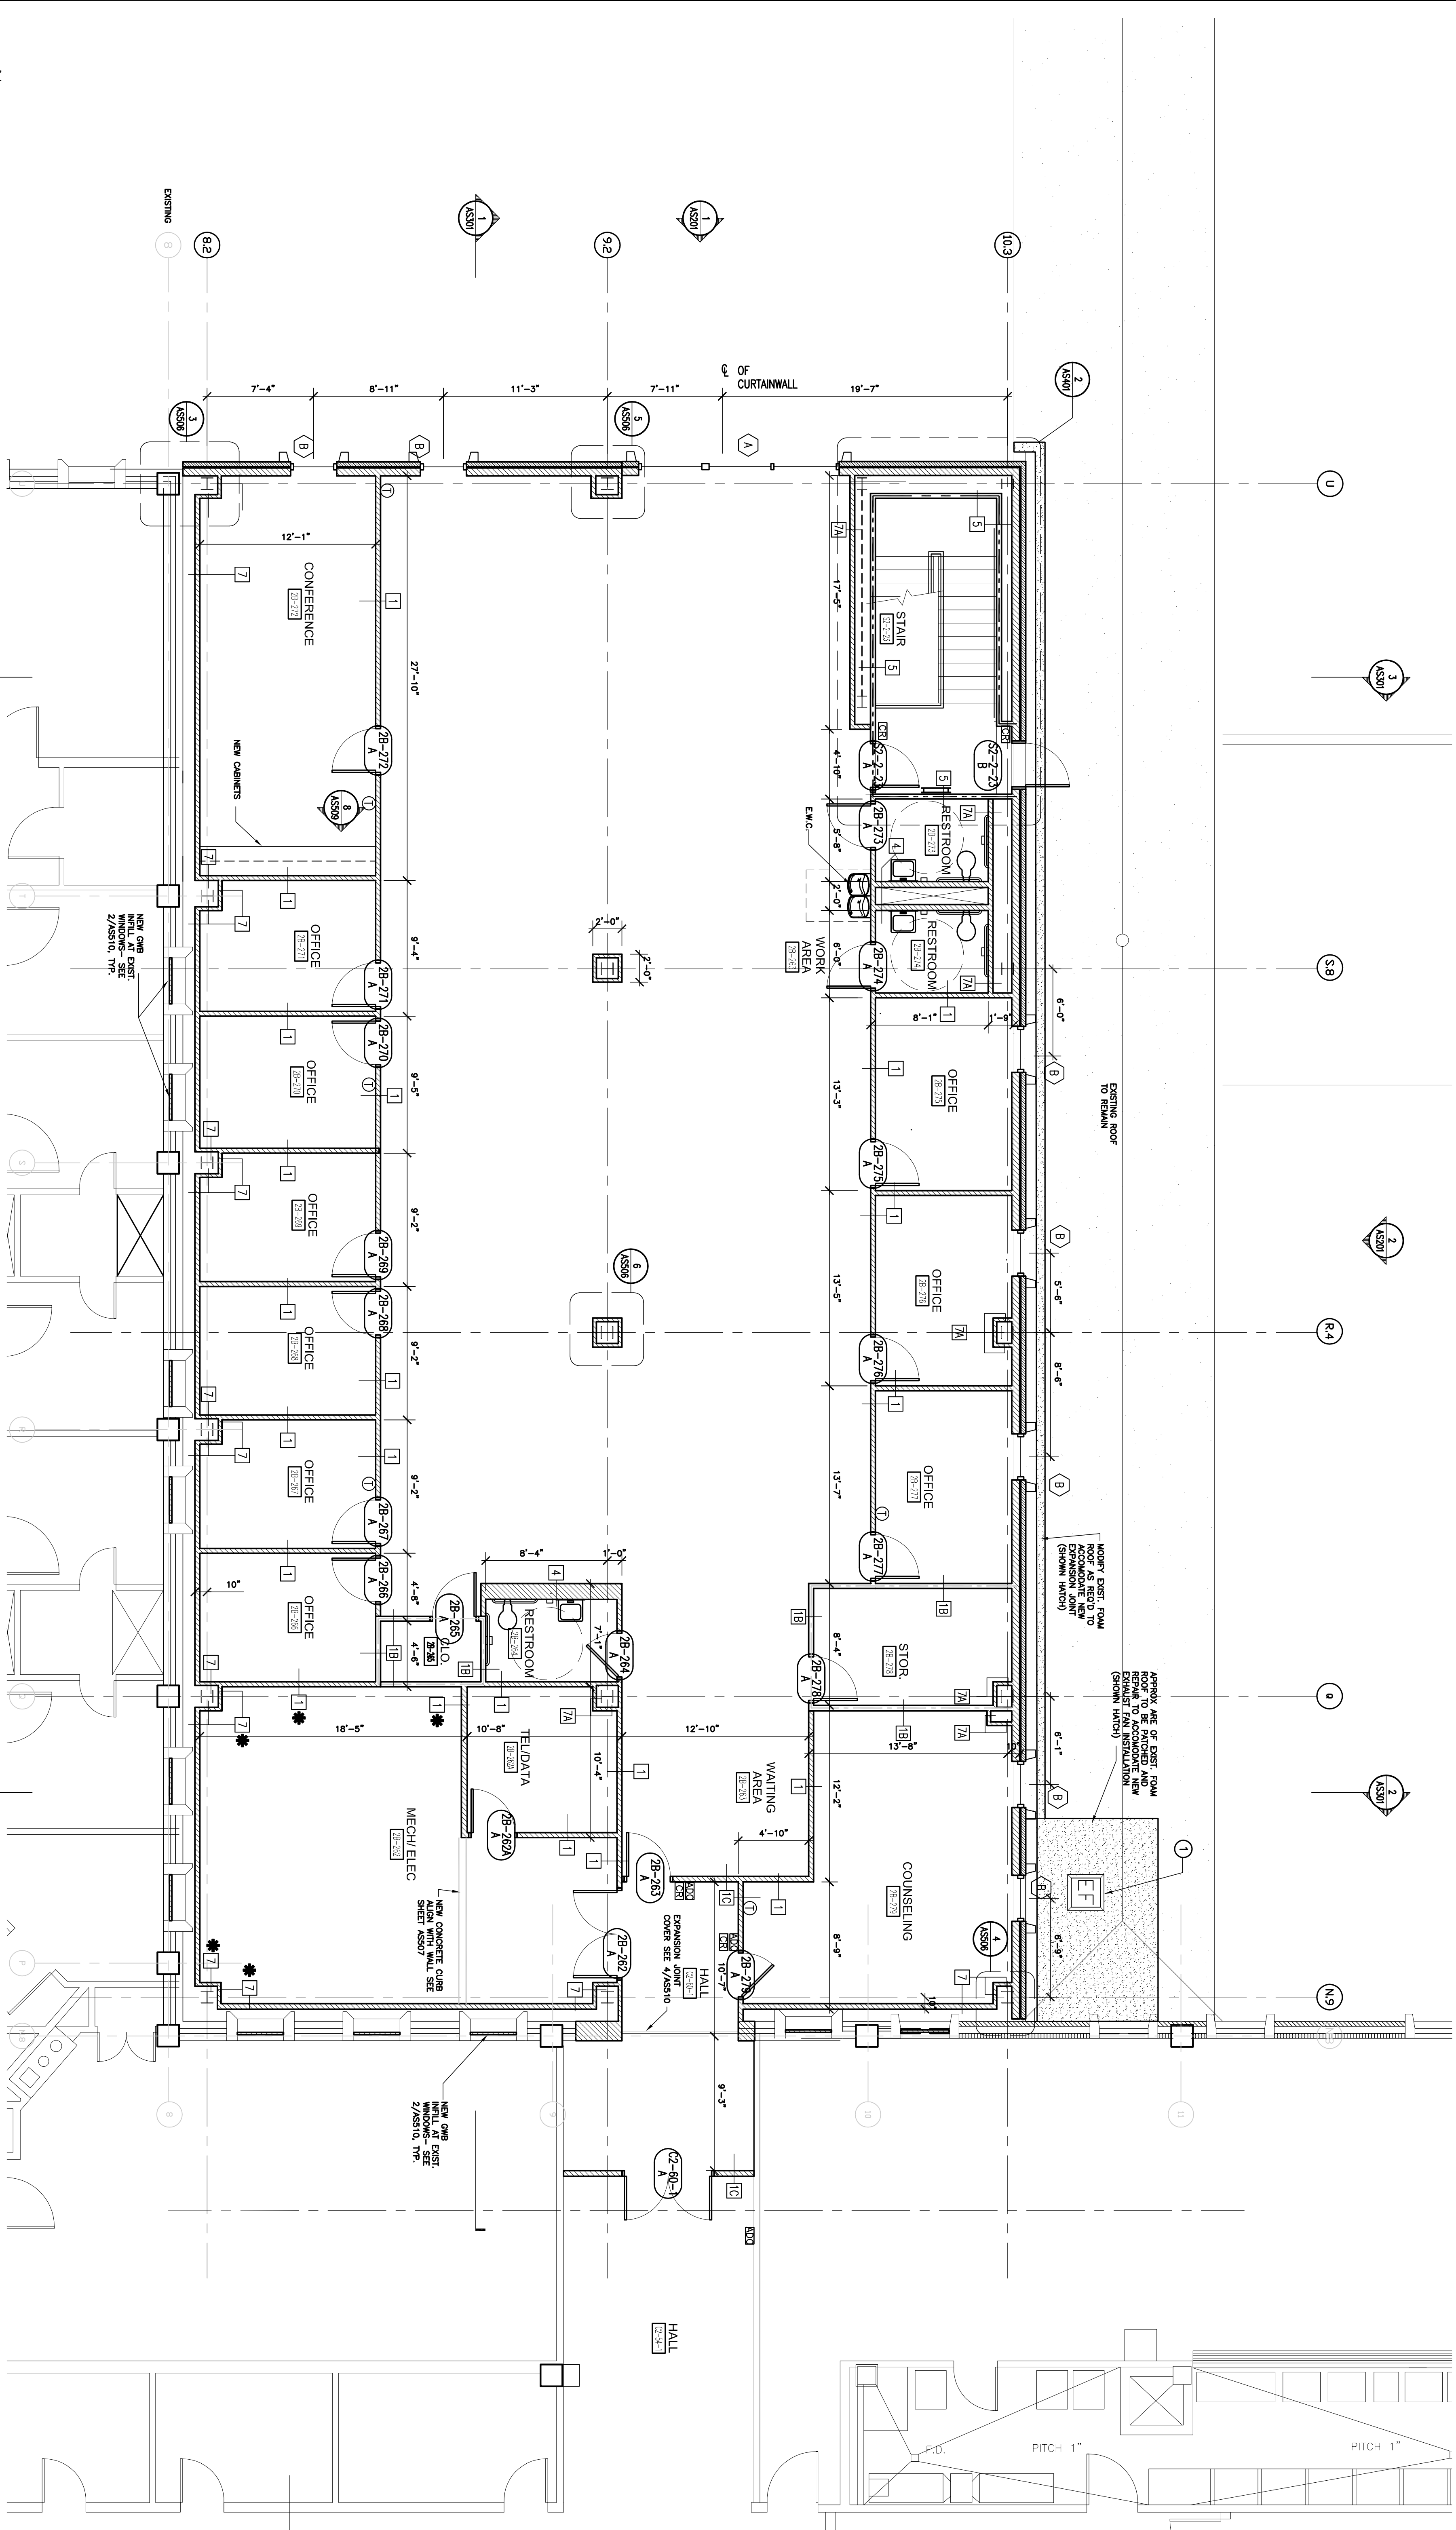

EXISTING 1ST FLOOR ROOF PLAN KEY NOTES

- NEW EXHAUST HOOD AT EXISTING 1ST FLOOR ROOF- SEE MECHANICAL. CAREFULLY CUT EXISTING ROOF ASSEMBLY, MODIFY EXISTING STRUCTURAL AS REQUIRED, PATCH AND REPAIR EXISTING ROOFING SYSTEM IN HATCHED AREA AS REQUIRED FOR WATER TIGHT CONDITION.

EXISTING 1ST FLOOR ROOF PLAN WORK- GENERAL NOTES



- THE EXISTING ROOF ASSEMBLY APPEARS TO BE A SPRAY-ON CLOSED CELL ASSEMBLY TYPED WITH A SINGLE PLY MEMBRANE, HOWEVER, GC'S ROOFING SUBCONTRACTOR SHALL VISIT THE SITE IN ORDER TO VERIFY AND CONFIRM THE EXISTING ROOFING ASSEMBLY. PRIOR TO ANY WORK OCCURRING, GC SHALL OBTAIN LETTER FROM THE APPROPRIATE ROOFING SYSTEM MANUFACTURER, TESTING GC'S SPECIFICATIONS AND CONFIRMING EXISTING ROOFING SYSTEM IS COMPATIBLE WITH THE EXISTING ROOF ASSEMBLY, AND WILL NOT VOID THE EXISTING ROOF WARRANTY.
- THE GENERAL SCOPE OF ROOFING WORK INCLUDES PATCHING, REPAIRING, WATERPROOFING, SHEETMETAL WORK, FLASHING, SEALING, ETC., AFFECTED BY THE SCOPE OF THE MECHANICAL WORK SCHEDULED TO OCCUR ON THE ROOF AS PART OF THIS PROJECT.
- ALL NEW ROOFING WORK SHALL BE PER THE CURRENT EDITIONS OF NATIONAL ROOFING CONTRACTORS' ASSOCIATION (NRCA) AND SHEET METAL AND AIR CONDITIONING CONTRACTORS' NATIONAL ASSOCIATION, INC. (SMACNA) RECOMMENDED DETAILS AND PRACTICES.
- ALL NEW MATERIALS AND METHODS USED ON THE EXISTING ROOF SHALL BE FULLY COMPATIBLE WITH THE EXISTING ROOF ASSEMBLY AS REQUIRED TO NOT VOID THE EXISTING ROOFING WARRANTY.
- ALL ROOFING AS PART OF THIS PROJECT WORK SHALL BE COMPLETED BY AN INSTALLER CERTIFIED BY THE EXISTING ROOFING SYSTEM MANUFACTURER WITH GC TO PROVIDE A LETTER FROM THE ROOFING SYSTEM MANUFACTURER LISTING THE PROPOSED INSTALLER AS A CERTIFIED INSTALLER.

NEW FLOOR PLAN GENERAL NOTES

- THE CONTRACTOR IS RESPONSIBLE FOR PROVIDING CLEAN SMOOTH WALL, FLOOR, AND CEILING SURFACES.
- CONTRACTOR SHALL BE RESPONSIBLE FOR EXTENDING ANY ITEMS SUCH AS OUTLETS, SWITCHES, AND ETC. TO THE NEW SURFACE.
- REPAIR OR REPLACE ANY EXISTING ITEMS SCHEDULED TO REMAIN THAT ARE DAMAGED DURING CONSTRUCTION AS REQ'D TO MATCH EXISTING.
- ALL PENETRATION THROUGH EXISTING FIRE RATED WALLS AND FLOORS MUST BE SEALED WITH AN ULT. APPROVED FIRE RATING REQUIREMENTS OF THE EXISTING SYSTEM KEEPING THE REQUIRED FIRE RATING REQUIREMENTS OF THE EXISTING EXISTING FLOORS- 2HR FIRE RATING UNLESS VERIFIED BY GC OTHERWISE EXISTING FIRE RATED WALLS- 2 HR FIRE RATING UNLESS VERIFIED BY GC OTHERWISE.
- GC TO ACOUSTICALLY / FIRE SEAL ALL PENETRATIONS THROUGH EXISTING WALLS, FLOORS, AND CEILINGS, TYP.
- GC TO COORDINATE WORK WITH ASBESTOS ABATEMENT CONTRACTOR REGARDING THE PRESENCE AND REMOVAL OF EXISTING ASBESTOS (REFER TO SPECIFICATIONS)
- TO DETERMINE THE LOCATION OF LOAD BEARING WALLS AND STRUCTURAL COLUMNS, THEN SYSTEMS SHALL BE SCHEDULED TO BE DEMOLISHED PRIOR TO THEM, WHEN IN DOUBT, CONTACT ARCHITECT PRIOR TO REMOVING ANY ITEMS IN QUESTION.
- CONTRACTOR SHALL COORDINATE WITH VA'S PROJECT MANAGER FOR WORK, THE SCHEDULE TO NOT INTERFERE WITH EXISTING OPERATIONS.
- THE FLOORS WILL BE OCCUPIED DURING CONSTRUCTION, CONSTRUCTION MUST BE PHASED AS TO NOT SHUT DOWN UTILITIES AND INFRASTRUCTURE (I.E. WATER, POWER, DATA, TELEPHONES, ETC.), AS REQUIRED TO MAINTAIN DAILY, UNINTERRUPTED OPERATIONS.
- ALL WORK REQUIRING THE USE OF TOOLS THAT WILL PRODUCE AN OBSTACLE AS REQUIRED FOR DEMOLITION OR NEW CONSTRUCTION SHALL BE SCHEDULED AND COORDINATED WITH VA PROJECT MANAGER PRIOR TO COMMENCING SAID WORK. NO TOOLS OR EQUIPMENT ARE TO BE STORED OR LEFT IN THE WORK AREA DUE TO OBSTACLE NOISE, FUMES, OR DUST.
- ALL WORK WILL BE SUBJECT TO BE SCHEDULING IF SO REQUESTED BY THE VA PROJECT MANAGER AND MAY OCCUR AT VA DISCRETION.
- ALL BLOCKING TO BE FIRE RETARDANT TYPE TYPE W/ C.C. TO PROVIDE ALL BACKING AS REQUIRED TO RIGIDLY ATTACH ALL NEW WALL MOUNTED ITEMS & ITEMS REQUIRING FASTENING TO THE WALLS.

NEW FLOOR PLAN LEGEND

- EXISTING STRUCTURAL GRIDLINE WINDOW TYPES- SEE AS502
- NEW STRUCTURAL GRIDLINE
- EXIST. ITEMS TO REMAIN
- NEW WALLS
- NEW ACCESS CONTROL DEVICE
- NEW AUTOMATIC DOOR OPERATOR
- NEW 1-HOUR FIRE RATED PARTITION- SEE 1/AS507
- NEW 2-HOUR FIRE RATED PARTITION- SEE 1/AS507
- WALL TYPES- SEE 1/AS507
- PROVIDE IN CAVITY CONC. CURB WITH SCHEDULED WALL TYPE- SEE AS507

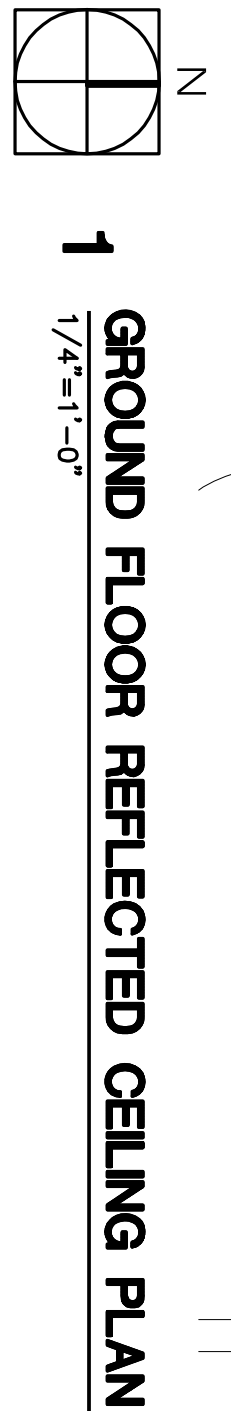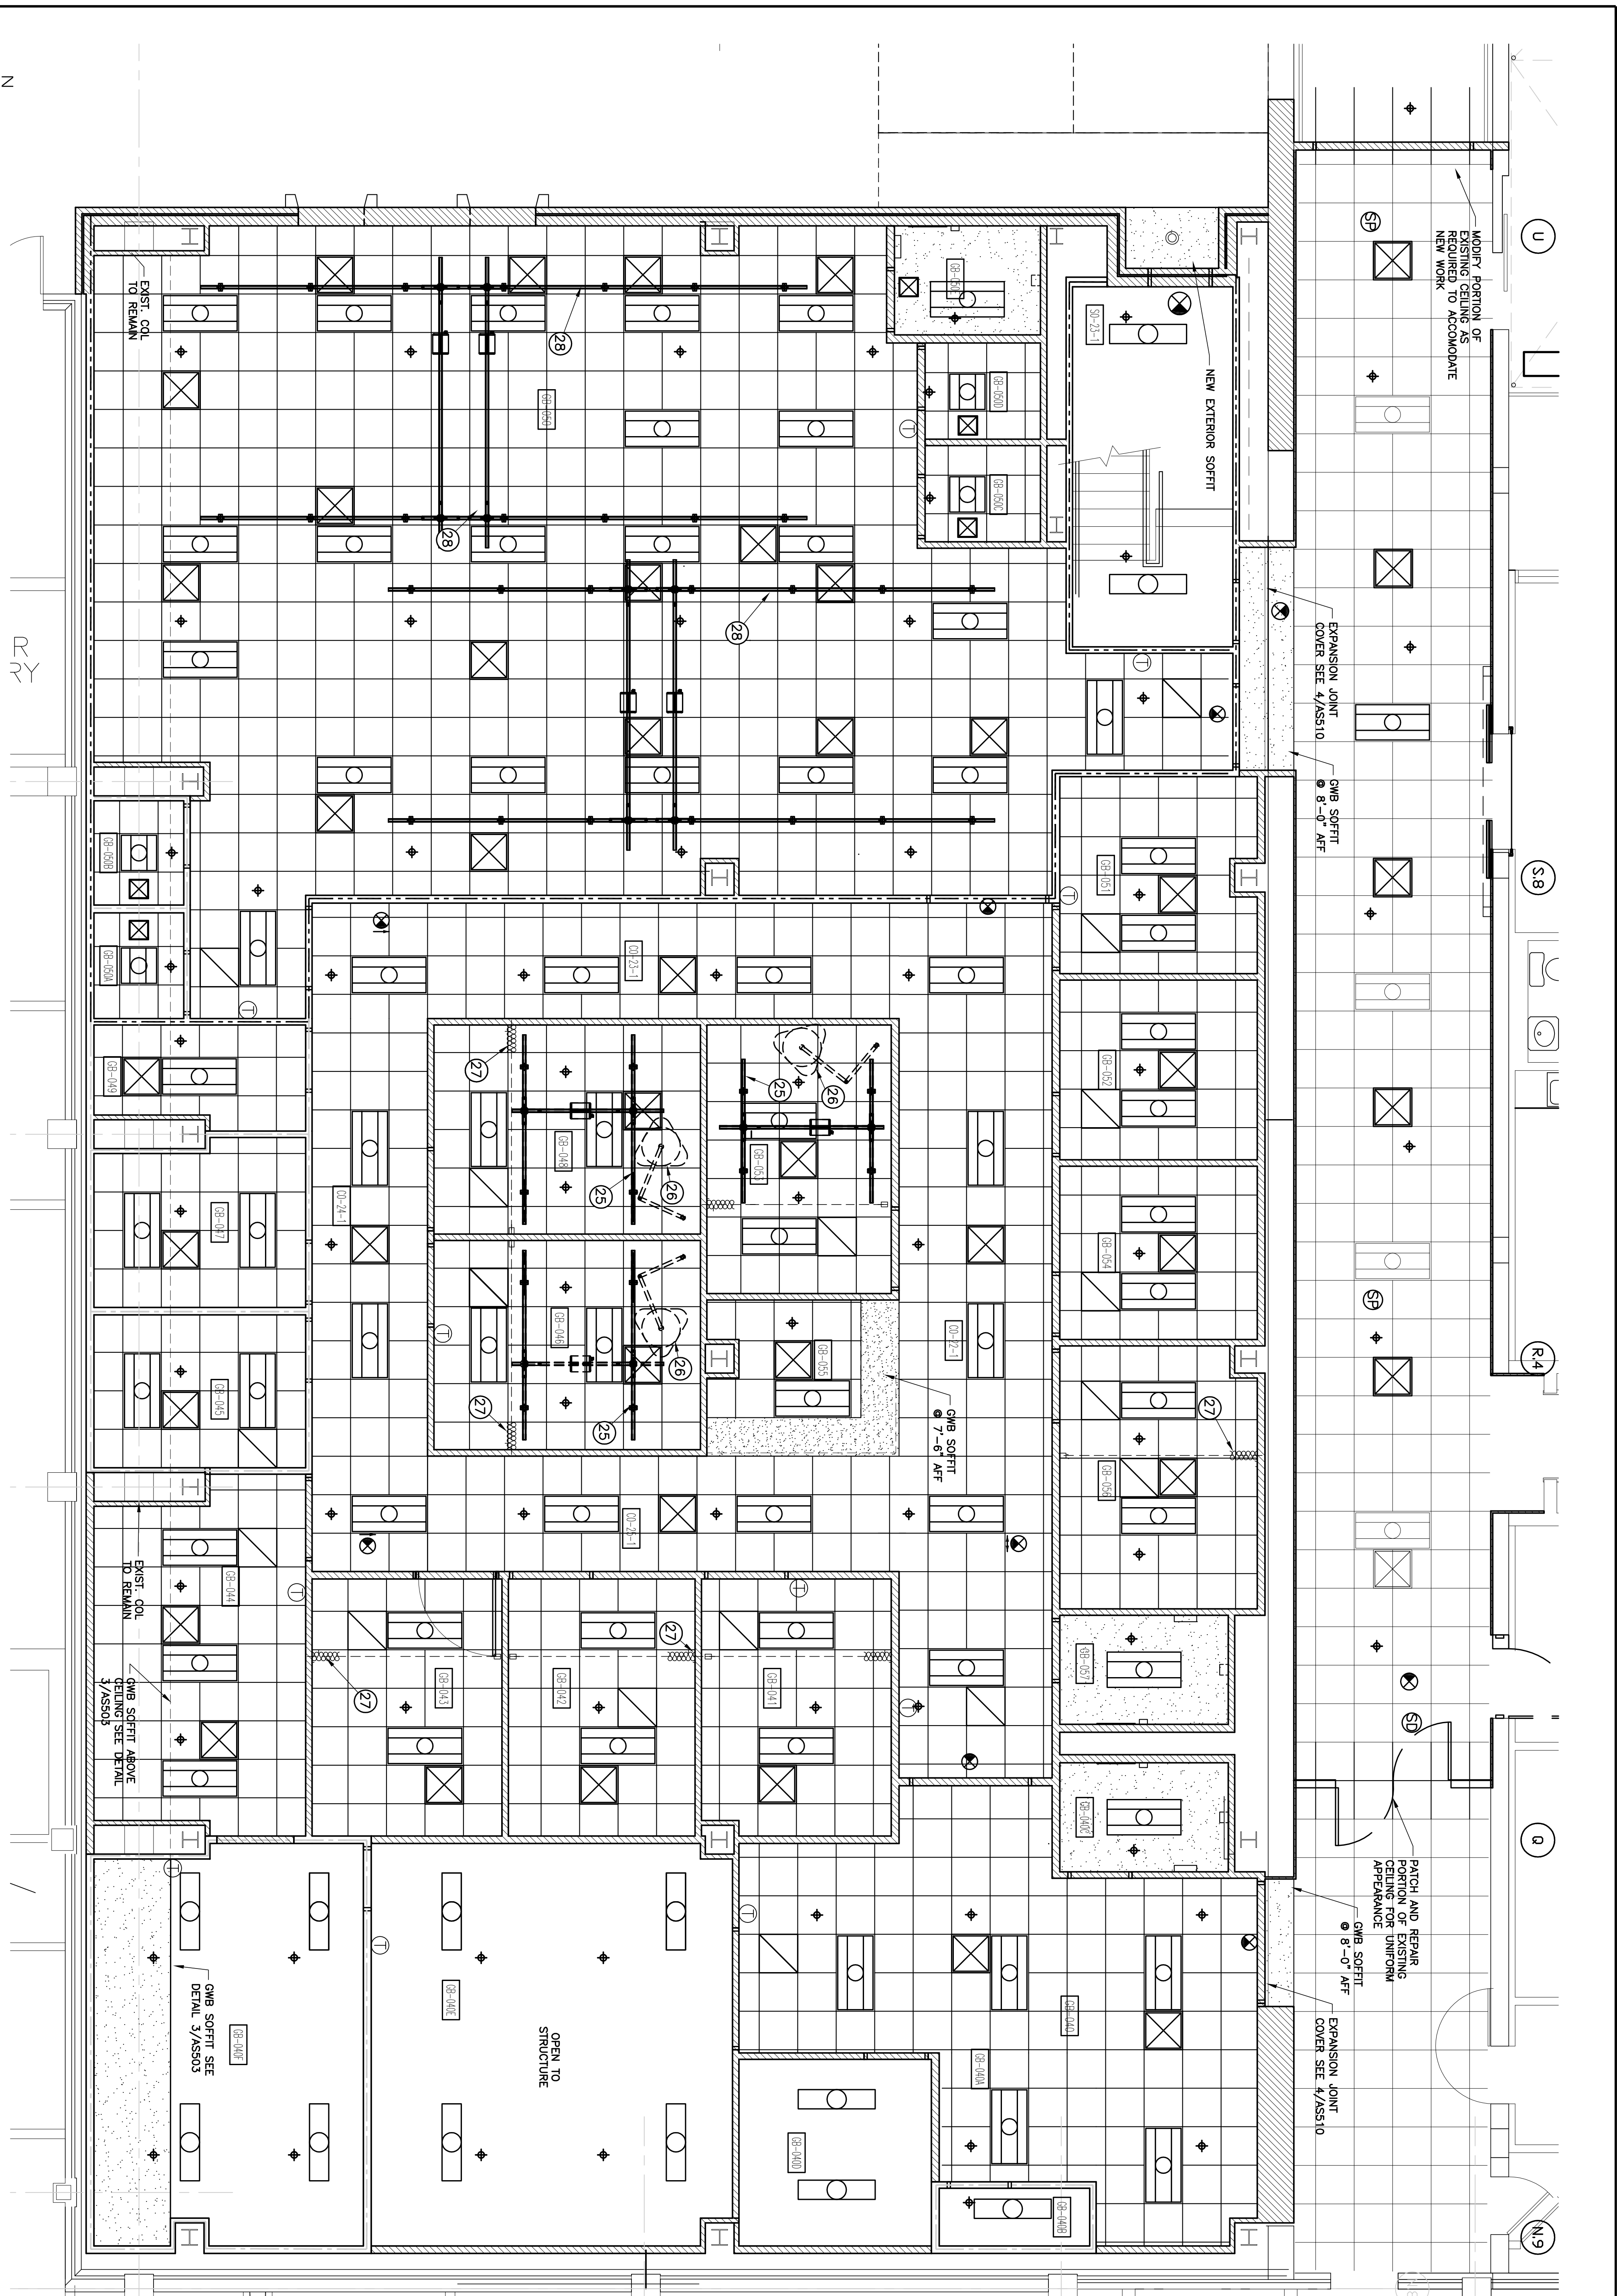


REFLECTED CEILING PLAN GENERAL NOTES

1. ALL NEW CEILINGS TO BE INSTALLED TO MATCH EXISTING CEILING HEIGHT, TYP. UNO
2. GC TO PATCH AND REPAIR ALL EXISTING DAMAGE CEILING AREA WITHIN THE AREA OF RENOVATION AS REQUIRED TO MATCH EXISTING OR AS REQ'D TO RECEIVE NEW FINISHES, TYP. UNO.
3. GC TO TAKE GREAT CARE WITH CEILING & ABOVE-CEILING WORK TO MINIMIZE DISTURBANCES TO THE EXISTING INFRASTRUCTURE IN PLACE GC TO COORDINATE CLOSELY WITH VA, STRUCTURAL, MECHANICAL, ELECTRICAL, PLUMBING, & FIRE PROTECTION FOR WORK IN THESE EXISTING FLOOR AREAS.
4. THERE IS A LARGE AMOUNT OF ABOVE-CEILING AND CEILING MOUNTED EQUIPMENT IN THE NEW AND OLD PROCEDURE ROOMS 18-104 & 18-108. GC TO TAKE GREAT CARE IN COORDINATING EQUIPMENT LOCATION, GC TO PROVIDE COMPLETE COORDINATION DRAWING FOR THIS CEILING SHOWING ALL COMPONENTS FOR REVIEW AND APPROVAL BY ARCHITECT AND VA AS PART OF THE SHOP DRAWING REVIEW PROCESS.

REVISION	DATE
001 SUBMITTAL	02/09/11
002 SUBMITTAL	02/29/11
003 SUBMITTAL	04/03/11
CONSTRUCTION SET	09/02/11
1. Corrections to Bid Options - ADDENDUM #4	11/09/11
MEDICAL EQUIPMENT AND INTERIOR DESIGN REVISIONS	04/08/12

CONSULTANTS:

ARCHITECT/ENGINEERS:

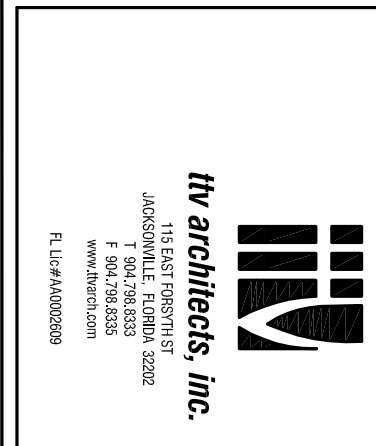

04-18-12 MEDICAL EQUIPMENT AND INTERIOR DESIGN REVISIONS

Drawing Title
GROUND FLOOR
REFLECTED CEILING PLAN
CEILING EQUIPMENT PLAN

Approved Project Director

Project Title
SPECIALTY TREATMENT EXPANSION
PROJECT - BUILDING #1

Location
JAMES A. HALEY VETERANS HOSPITAL

Date
02/9/11

Checked
TTV

Drawn
TAG

Dwg. # of
9 of 40

Project Number
673-CS1-100


Building Number
1

Drawing Number
AS105

Office of
Construction
and Facilities
Management

Department of
Veterans Affairs

KEY PLAN

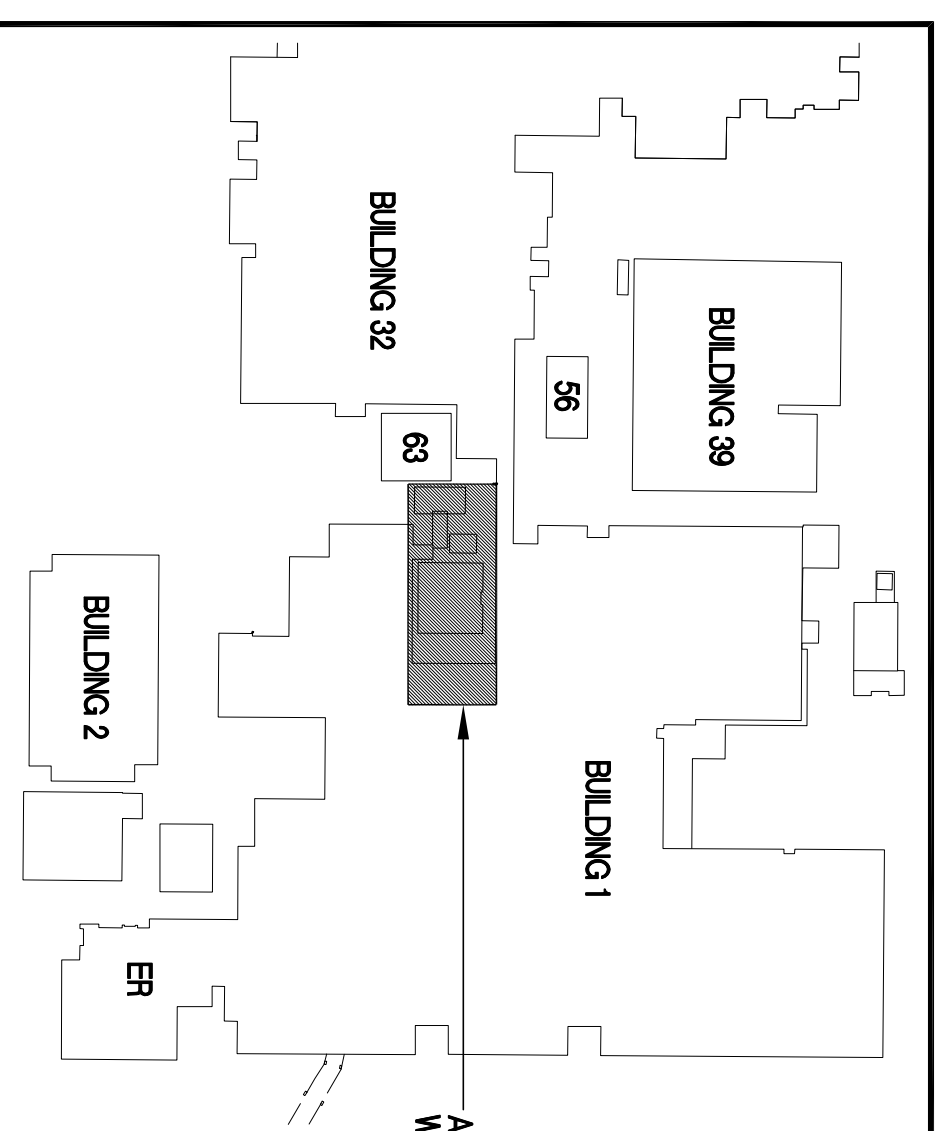


REFLECTED CEILING PLAN LEGEND

- NEW RECESSED DOWNLIGHT
- NEW EXIT LIGHT
- SHADED AREA INDICATES UP FACE
- ARROW INDICATES DIRECTION OF EXIT TRAVEL (IF APPLICABLE)
- NEW LAV-IN RETURN OR SUPPLY GRILLE
- NEW LINEAR DIFFUSER- SEE MECHANICAL & INTERIOR ELEVATIONS FOR LOCATIONS.
- NEW SPRINKLER HEAD
- THERMOSTAT-SEE MECHANICAL DRAWING
- EXISTING ACT GRID AND TILE TO REMAIN
- PATCH AND REPAIR AS REQ'D TO MATCH EXISTING.
- NEW PERIMETER WALLBOARD (GWB)
- NEW 2X4 DIRECT/INDIRECT LIGHT FIXTURE
- NEW 2X2 LIGHT FIXTURE
- NEW 1X4 STRIP LIGHT FIXTURE


GROUND FLOOR EQUIPMENT SCHEDULE
(VERIFY W/ ACTUAL EQUIPMENT)

ITEM #	DESCRIPTION	PROVIDED BY	INSTALLED BY
1	SIGMA 40 MONOPLACE HYPERBARIC CHAMBER	PERRY BIOMEDICAL	PERRY BIOMEDICAL
2	FUTURE MULTIPLACE HYPERBARIC CHAMBER	--	--
3	RESTROOM (TOILET, SINK, GRAB BARS, & ACCESSORIES)	GC	GC
4	BENCH	GC	GC
5	PATIENT LOCKERS (4 PER ROOM)	GC	GC
6	NURSE STATION (MILWORK)	GC	GC
7	NURSE STATION EQUIPMENT (CHAIR, PHONE)	VA	VA
8	WALL MOUNTED CLOCK	VA	VA
9	EXAM TABLE	VA	VA
10	INSTRUMENT CABINET	VA	GC
11	HANDSINK (SOAP, P.I. DISPENSER, HAND SANITIZER BY VA)	GC	GC
12	STAINLESS STEEL SHELF 12"x5"	GC	GC
13	SHARPS BOX	VA	VA
14	GLOVE DISPENSER	VA	VA
15	NURSE CALL	GC	GC
16	(2) COAT HOOKS	GC	GC
17	BULLETIN BOARD/MAGAZINE RACK	VA	VA
18	CHAIR	VA	VA
19	MODULAR WORKSTATION (INCLUDING COMPUTER)	VA	VA
20	EXAM STOOL	VA	GC
21	TV WALL MOUNT	GC	GC
22	TV W/ TELECONFERENCING EQUIPMENT	VA	VA
23	WASTE RECEPTACLE	VA	VA
24	PAPER TOWEL DISPENSER	VA	VA
25	LINOROLL CEILING TRAVELER 2X2 PATIENT LIFT	GC	GC
26	BURTON VISIONARY SINGLE HEAD O.R. LIGHT	GC	GC
27	CUBICLE CURTAIN	GC	GC
28	LINOROLL CEILING TRAVELER BARATIC PATIENT LIFT	GC	GC

ALL PRODUCTS LISTED ARE TO BE BASED ON THE BASIS OF DESIGN. REFER TO MANUFACTURER'S DRAWINGS FOR ADDITIONAL INFORMATION.

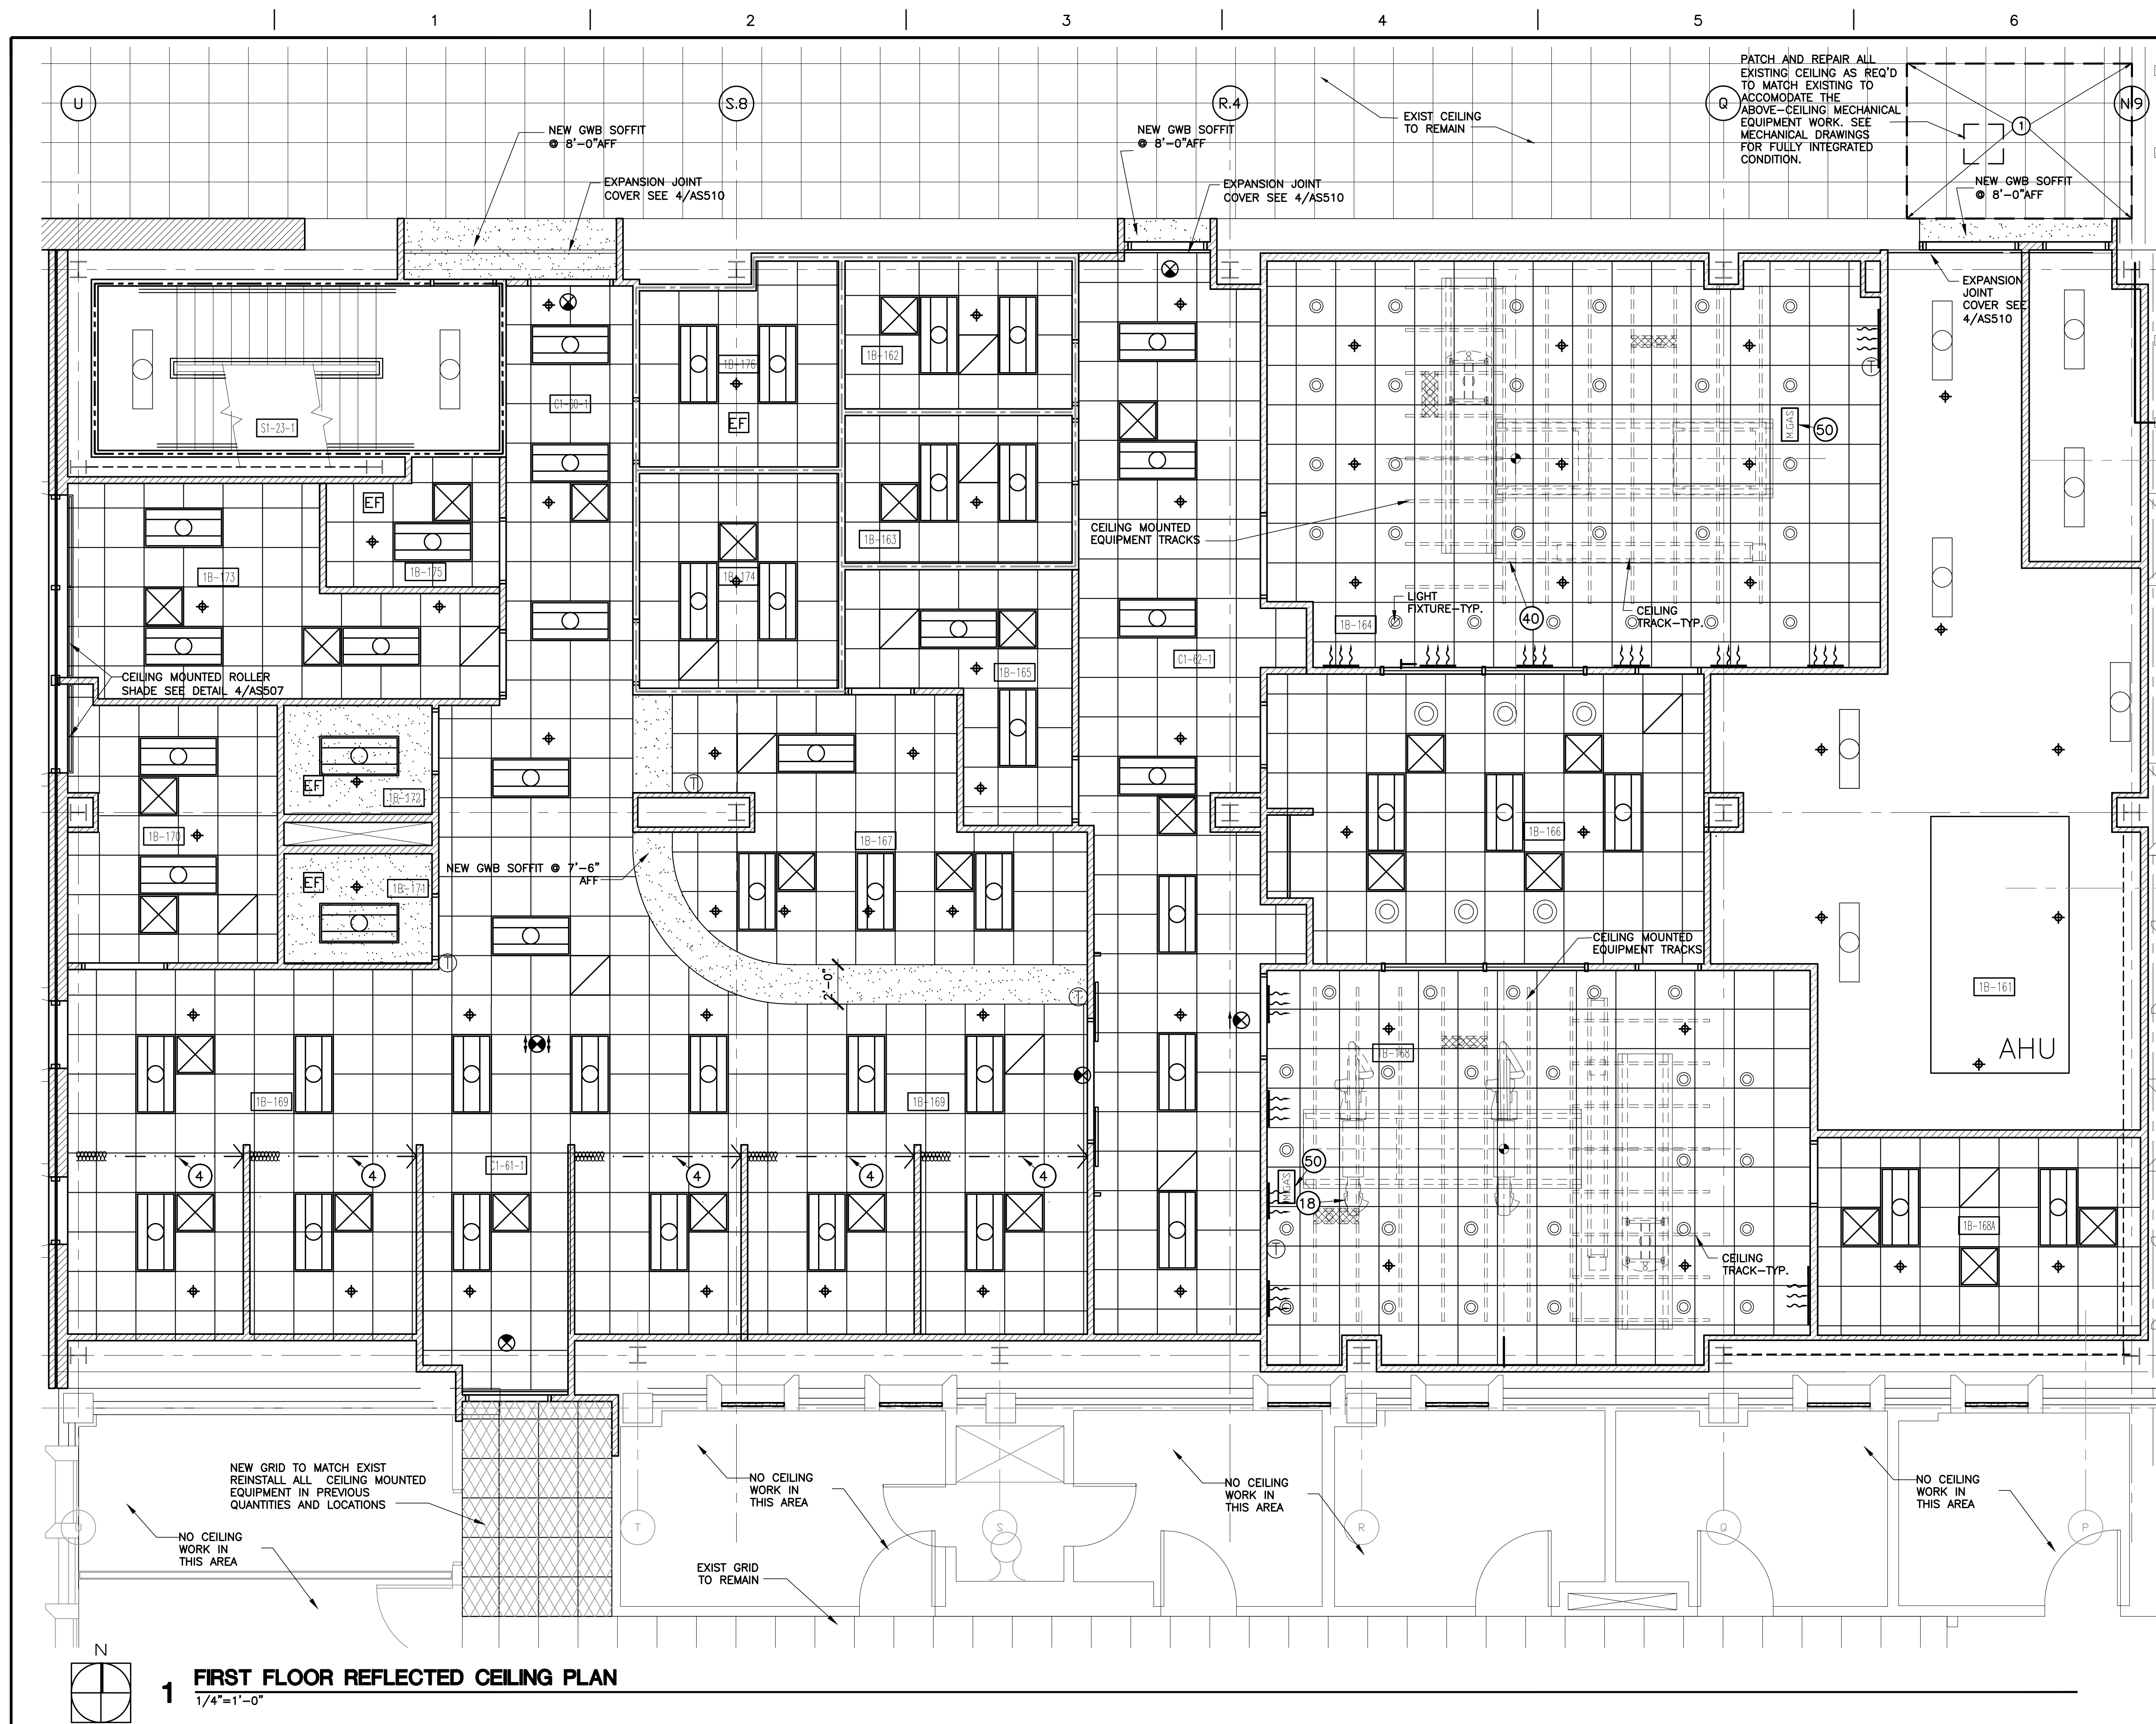

1ST FLOOR EQUIPMENT SCHEDULE (VERIFY W/ ACTUAL EQUIPMENT)			
ITEM #	DESCRIPTION	PROVIDED BY	INSTALLED BY
1	PATIENT BED	VA	VA
2	PATIENT CARE MONITOR W/ SUPPORT ASSEMBLY	VA	GC
3	PATIENT CARE/HEADWALL W/ OXYGEN, SUCTION, & AIRLINE	GC	GC
4	PRIVACY CURTAIN	GC	GC
5	T.V. MONITOR SWINGARM BY G.C. W/ T.V PROVIDED BY VA	GC	GC
6	MOVEABLE PATIENT STORAGE UNIT	VA	VA
7	NURSE STATION (MILLWORK)	GC	GC
8	NURSE STATION EQUIPMENT (CHAIR, PHONE)	VA	VA
9	WALL MOUNTED CLOCK	VA	VA
10	HANDSINK (SOAP, P.T. DISPENSER, HAND SANTIZER BY VA)	GC	GC
BIPLANE EQUIP.			
11	AXIS IMAGE SYSTEM	SIEMENS	SIEMENS
12	COMPUTER CONTROL WORKSTATION	SIEMENS	SIEMENS
13	TABLE CONTROL MODULES	SIEMENS	SIEMENS
14	ACE (ARCHIVE CONTROL EXTENSION)	SIEMENS	SIEMENS
15	WORKSURFACE	GC	GC
16	DCS 6 DISPLAY CEILING SUSPENSION	SIEMENS	SIEMENS
17	ARTIS ZEE BIPLANE ANGIO FLOOR STAND W/ MOUNTING PLATE	SIEMENS	SIEMENS
18	ARTIS ZEE BIPLANE ANGIO CEILING STAND W/ LONGITUDINAL RAILS	SIEMENS	SIEMENS
19	PATIENT TABLE (OR)	SIEMENS	SIEMENS
20	UPPER BODY RADIATION SHIELD 4 M. TRACK	SIEMENS	SIEMENS
21	MAVIG R96 O.R. LAMP	SIEMENS	SIEMENS
22	COOLING UNITS (2)	SIEMENS	SIEMENS
23	POLYDOROS A100 (POWER UNIT 1)	SIEMENS	SIEMENS
24	POLYDOROS A100 (POWER UNIT 2)	SIEMENS	SIEMENS
25	CABLE CABINET	SIEMENS	SIEMENS
26	SYSTEM CONTROL CABINET	SIEMENS	SIEMENS
27	SYSTEM CONTROL CABINET 2	SIEMENS	SIEMENS
28	SYSTEM CONTROL CABINET (OR TABLE ONLY)	SIEMENS	SIEMENS
ANGIO EQUIP.			
29	AXIS IMAGE SYSTEM W/ UPS	SIEMENS	SIEMENS
30	ACE (ARCHIVE CONTROL EXTENSION)	SIEMENS	SIEMENS
31	COMPUTER CONTROL WORKSTATION	SIEMENS	SIEMENS
32	WORKSURFACE	GC	GC
33	TERASON ULTRASOUND INTEGRATION KIT	SIEMENS	SIEMENS
34	TABLE CONTROL MODULES	SIEMENS	SIEMENS
35	SYNGO X JOYSTICK	SIEMENS	SIEMENS
36	DCS 4M DISPLAY CEILING SUSPENSION	SIEMENS	SIEMENS
37	MONITOR CART	SIEMENS	SIEMENS
38	ARTIS ZEE CEILING C-ARM STAND	SIEMENS	SIEMENS
39	PATIENT TABLE	SIEMENS	SIEMENS
40	UPPER BODY RADIATION SHIELD 4 M. TRACK	SIEMENS	SIEMENS
41	MAVIG R96 O.R. LAMP	SIEMENS	SIEMENS
42	COOLING UNITS	SIEMENS	SIEMENS
43	POLYDOROS A100 (POWER UNIT 1)	SIEMENS	SIEMENS
44	CABLE CABINET	SIEMENS	SIEMENS
45	SYSTEM CONTROL CABINET	SIEMENS	SIEMENS
46	SYSTEM CONTROL CABINET (OR TABLE ONLY)	SIEMENS	SIEMENS
47	MEDRAD MARK V PROVIS INJECTOR TABLE BRACKET	MEDRAD	MEDRAD
48	MEDRAD MARK V PROVIS INJECTOR REMOTE CONTROL	MEDRAD	MEDRAD
49	MEDRAD MARK V PROVIS INJECTOR ELECTRONICS BOX	MEDRAD	MEDRAD
50	CEILING MEDICAL GAS OUTLET	GC	GC
ALL PRODUCTS LISTED ARE TO SERVE AS THE BASIS OF DESIGN. REFER TO MANUFACTURER'S DRAWINGS FOR ADDITIONAL INFORMATION.			

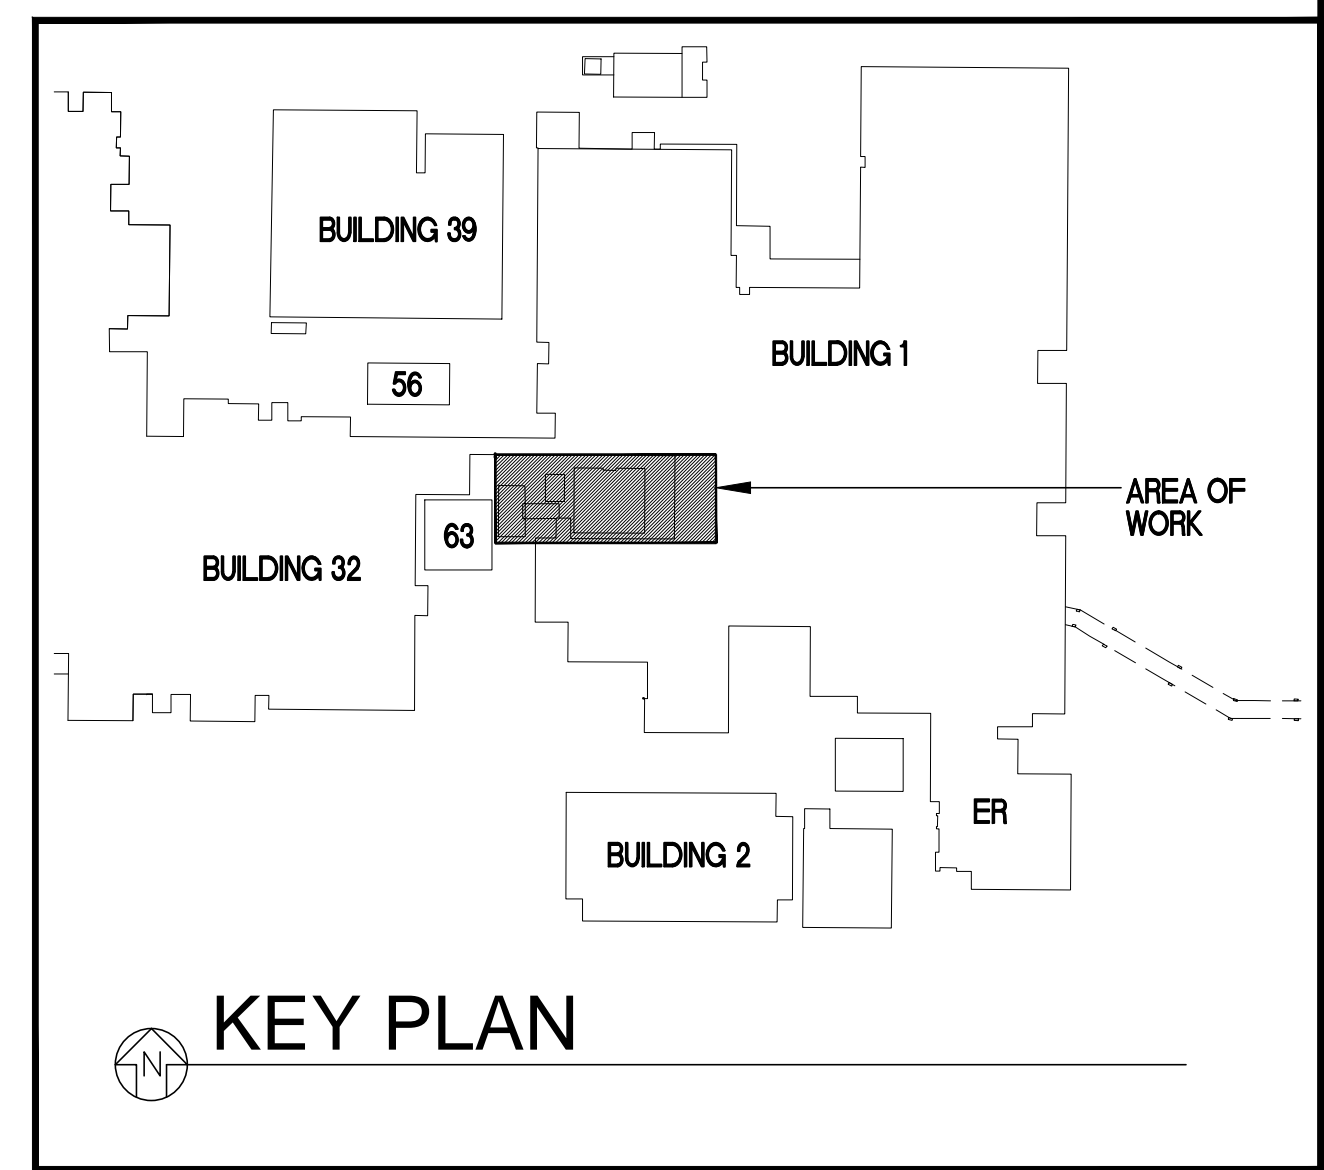

REFLECTED CEILING PLAN GENERAL NOTES

- ALL NEW CEILINGS TO BE INSTALLED TO MATCH EXISTING CEILING HEIGHT, TYP. UNO
- GC TO PATCH AND REPAIR ALL EXISTING DAMAGE CEILING AREA WITHIN THE AREA OF RENOVATION AS REQUIRED TO MATCH EXISTING OR AS REQ'D TO RECEIVE NEW FINISHES, TYP. UNO.
- GC TO TAKE GREAT CARE WITH CEILING & ABOVE-CEILING WORK TO MINIMIZE DISTURBANCES TO THE EXISTING INFRASTRUCTURE IN PLACE GC TO COORDINATE CLOSELY WITH VA, STRUCTURAL, MECHANICAL, ELECTRICAL, PLUMBING, & FIRE PROTECTION FOR WORK IN THESE EXISTING FLOOR AREAS.
- THERE IS A LARGE AMOUNT OF ABOVE-CEILING AND CEILING MOUNTED EQUIPMENT IN THE NEW ANGIO PROCEDURE ROOMS 1B-164 & 1B-168. GC TO TAKE GREAT CARE IN COORDINATING ALL ITEMS IN THE CEILING AREA TO ENSURE THAT ALL CLEARANCES, LOCATIONS, OPERABILITY, REQUIREMENTS, ETC. ARE MAINTAINED AS REQUIRED FOR FULLY ORGANIZED, OPERABLE, CODE COMPLIANT CONDITION. GC TO PROVIDE COMPLETE COORDINATION DRAWING FOR THIS CEILING SHOWING ALL COMPONENTS FOR REVIEW AND APPROVAL BY ARCHITECT AND VA AS PART OF THE SHOP DRAWING REVIEW PROCESS.

REFLECTED CEILING PLAN LEGEND

- | | | | | | |
|--|--|--|--|--|---|
| | NEW 2X2 ACT GRID AND TILE | | NEW 2X2 LIGHT FIXTURE | | NEW LINEAR DIFFUSER- SEE MECHANICAL & INTERIOR ELEVATIONS FOR LOCATIONS. |
| | EXISTING ACT GRID AND TILE TO REMAIN | | NEW 1X4 STRIP LIGHT FIXTURE | | NEW SPRINKLER HEAD |
| | NEW GYPSUM WALLBOARD (GWB) CEILING OR SOFFIT | | NEW RECESSED DOWNLIGHT | | THERMOSTAT-SEE MECHANICAL DRAWING |
| | NEW 2X4 DIRECT/INDIRECT LIGHT FIXTURE | | NEW EXIT LIGHT | | NEW APPLIED FIREPROOFING ON EXISTING STRUCTURE ABOVE WITH CONTRAST SEALER |
| | | | SHADED AREA INDICATES UT FACE | | |
| | | | ARROW INDICATES DIRECTION OF EXIT TRAVEL (IF APPLICABLE) | | |
| | | | NEW LAY-IN RETURN OR SUPPLY GRILLE | | |

04-18-12 MEDICAL EQUIPMENT AND INTERIOR DESIGN REVISIONS

REVISION	DATE
65% SUBMITTAL	02/19/11
95% SUBMITTAL	03/29/11
100% SUBMITTAL	04/19/11
CONSTRUCTION SET	05/02/11
Clarifications to Bid Options- ADDENDUM #4	11/09/11
MEDICAL EQUIPMENT AND INTERIOR DESIGN REVISIONS	04/18/12

CONSULTANTS:

ARCHITECT/ENGINEERS:



Drawing Title
FIRST FLOOR
REFLECTED CEILING PLAN +
CEILING EQUIPMENT PLAN

Approved Project Director

Project Title
SPECIALTY TREATMENT EXPANSION
PROJECT- BUILDING #1

Location
JAMES A. HALEY VETERANS' HOSPITAL

Date
02/19/11

Checked
TTV

Drawn
TAG

Project Number
673-CSI-100


Building Number
1

Drawing Number
AS106

Dwg 10 of 40

Office of
Construction
and Facilities
Management

Department of
Veterans Affairs

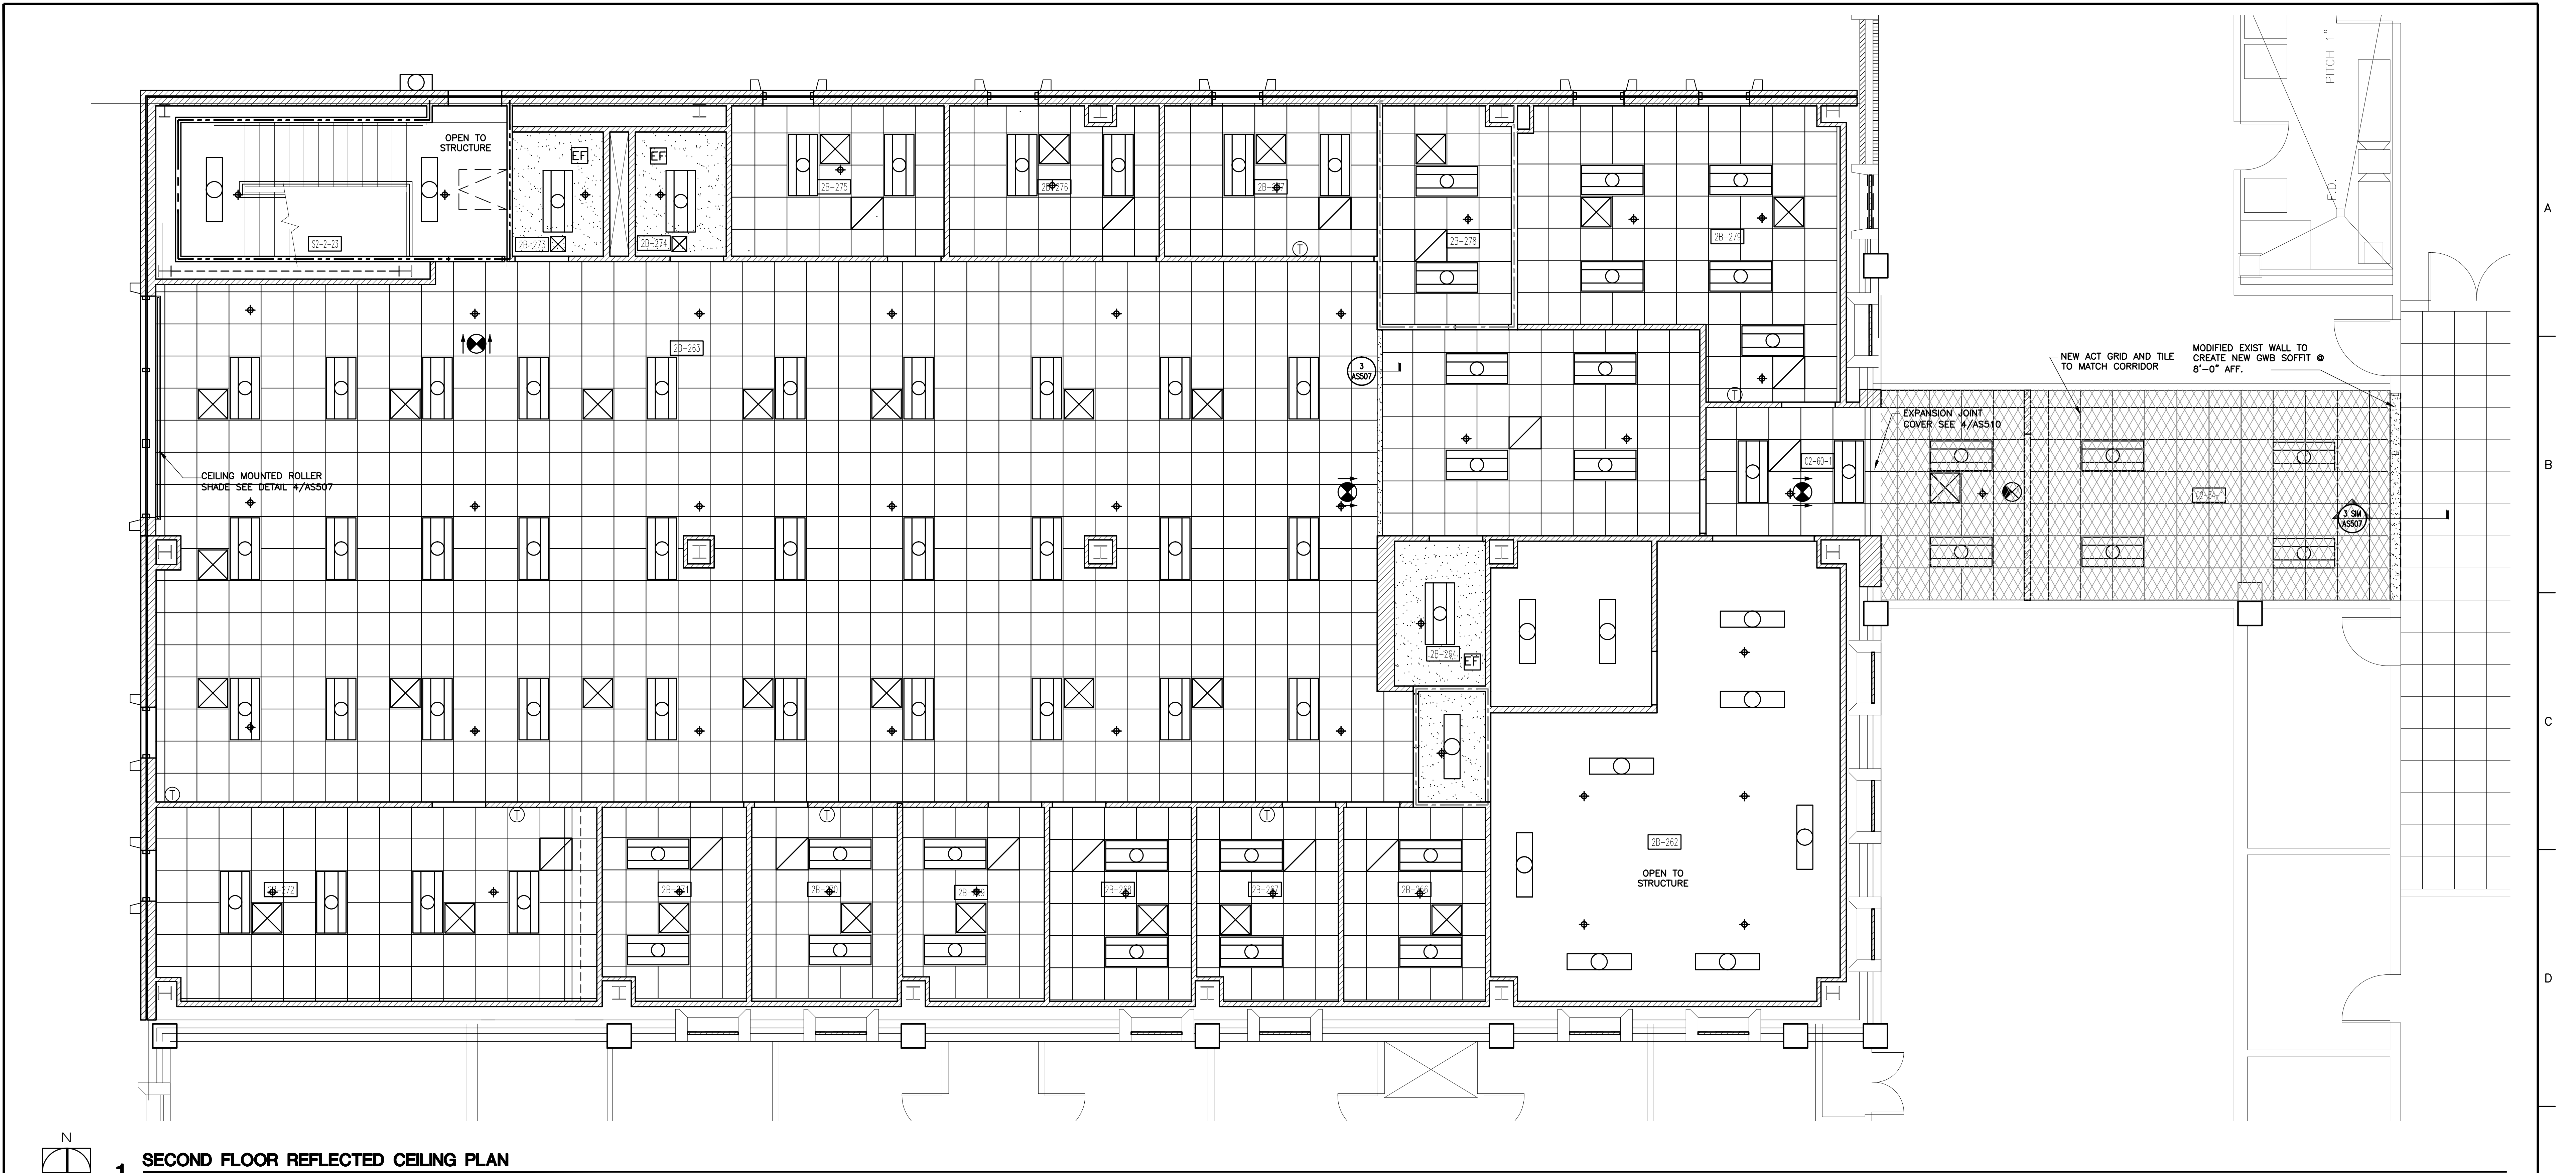

1 SECOND FLOOR REFLECTED CEILING PLAN
1/4"=1'-0"

REFLECTED CEILING PLAN GENERAL NOTES


- ALL NEW CEILINGS TO BE INSTALLED TO MATCH EXISTING CEILING HEIGHT, TYP. UNO
- GC TO PATCH AND REPAIR ALL EXISTING DAMAGE CEILING AREA WITHIN THE AREA OF RENOVATION AS REQUIRED TO MATCH EXISTING OR AS REQ'D TO RECEIVE NEW FINISHES, TYP. UNO.
- GC TO TAKE GREAT CARE WITH CEILING & ABOVE-CEILING WORK TO MINIMIZE DISTURBANCES TO THE EXISTING INFRASTRUCTURE IN PLACE. GC TO COORDINATE CLOSELY WITH VA, STRUCTURAL, MECHANICAL, ELECTRICAL, PLUMBING, & FIRE PROTECTION FOR WORK IN THESE EXISTING FLOOR AREAS.
- THERE IS A LARGE AMOUNT OF ABOVE-CEILING AND CEILING MOUNTED EQUIPMENT IN THE NEW ANGIO PROCEDURE ROOMS 1B-164 & 1B-168. GC TO TAKE GREAT CARE IN COORDINATING ALL ITEMS IN THE CEILING AREA TO ENSURE THAT ALL CLEARANCES, LOCATIONS, OPERABILITY, REQUIREMENTS, ETC. ARE MAINTAINED AS REQUIRED FOR FULLY ORGANIZED, OPERABLE, CODE COMPLIANT CONDITION. GC TO PROVIDE COMPLETE COORDINATION DRAWING FOR THIS CEILING SHOWING ALL COMPONENTS FOR REVIEW AND APPROVAL BY ARCHITECT AND VA AS PART OF THE SHOP DRAWING REVIEW PROCESS

REFLECTED CEILING PLAN LEGEND

- | | | | |
|--|---|--|--|
| | NEW 2X2 ACT GRID AND TILE | | NEW 2X2 LIGHT FIXTURE |
| | EXISTING ACT GRID AND TILE TO REMAIN PATCH AND REPAIR AS REQ'D TO MATCH EXISTING. | | NEW 1X4 STRIP LIGHT FIXTURE |
| | NEW GYPSUM WALLBOARD (GWB) CEILING OR SOFFIT | | NEW RECESSED DOWNLIGHT |
| | NEW 2X4 DIRECT/INDIRECT LIGHT FIXTURE | | NEW EXIT LIGHT
SHADED AREA INDICATES LIT FACE |
| | | | ARROW INDICATES DIRECTION OF EXIT TRAVEL (IF APPLICABLE) |
| | | | NEW LAY-IN RETURN OR SUPPLY GRILLE |

- | | |
|--|---|
| | NEW LINEAR DIFFUSER- SEE MECHANICAL & INTERIOR ELEVATIONS FOR LOCATIONS. |
| | NEW SPRINKLER HEAD |
| | THERMOSTAT-SEE MECHANICAL DRAWING |
| | NEW APPLIED FIREPROOFING ON EXISTING STRUCTURE ABOVE WITH CONTRAST SEALER -- NOT THAT REPLACEMENT OF ALL EXISTING FIRE PROOFING DAMAGED BY CONTRACTOR IS NOT GRAPHICALLY IDENTIFIED HERE, BUT IS STILL REQUIRED |
| | ROOF SCUTTLE ABOVE |

04-18-12 MEDICAL EQUIPMENT AND INTERIOR DESIGN REVISIONS

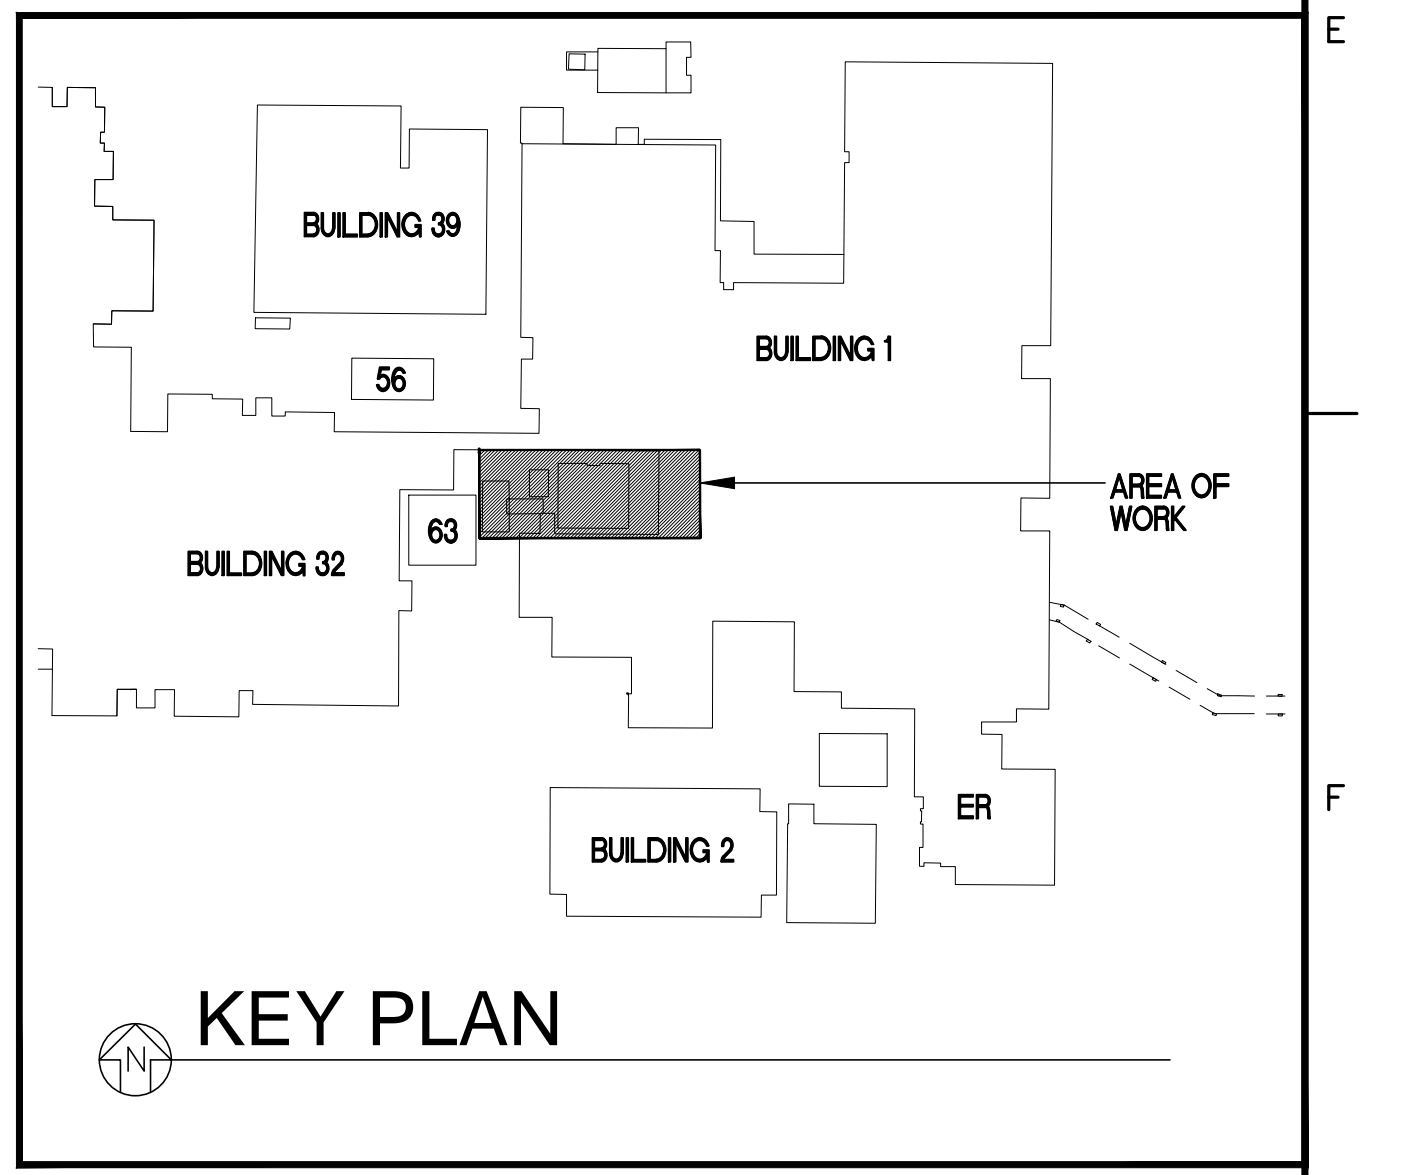

REVISION	DATE
65% SUBMITTAL	02/19/11
95% SUBMITTAL	03/29/11
100% SUBMITTAL	04/19/11
CONSTRUCTION SET	05/02/11
Clarifications to Bid Options- ADDENDUM #4	11/09/11
MEDICAL EQUIPMENT AND INTERIOR DESIGN REVISIONS	04/18/12

CONSULTANTS:

ARCHITECT/ENGINEERS:



Drawing Title
SECOND FLOOR
REFLECTED CEILING PLAN

Approved Project Director

Project Title
SPECIALTY TREATMENT EXPANSION
PROJECT- BUILDING #1

Location
JAMES A. HALEY VETERANS' HOSPITAL

Date
02/19/11

Checked
TTV

Drawn
TAG

Project Number
673-CSI-100



Building Number
1

Drawing Number
AS107

Dwg. 11 of 40

Office of
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and Facilities
Management

Department of
Veterans Affairs

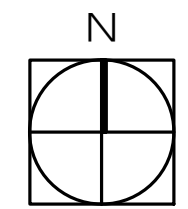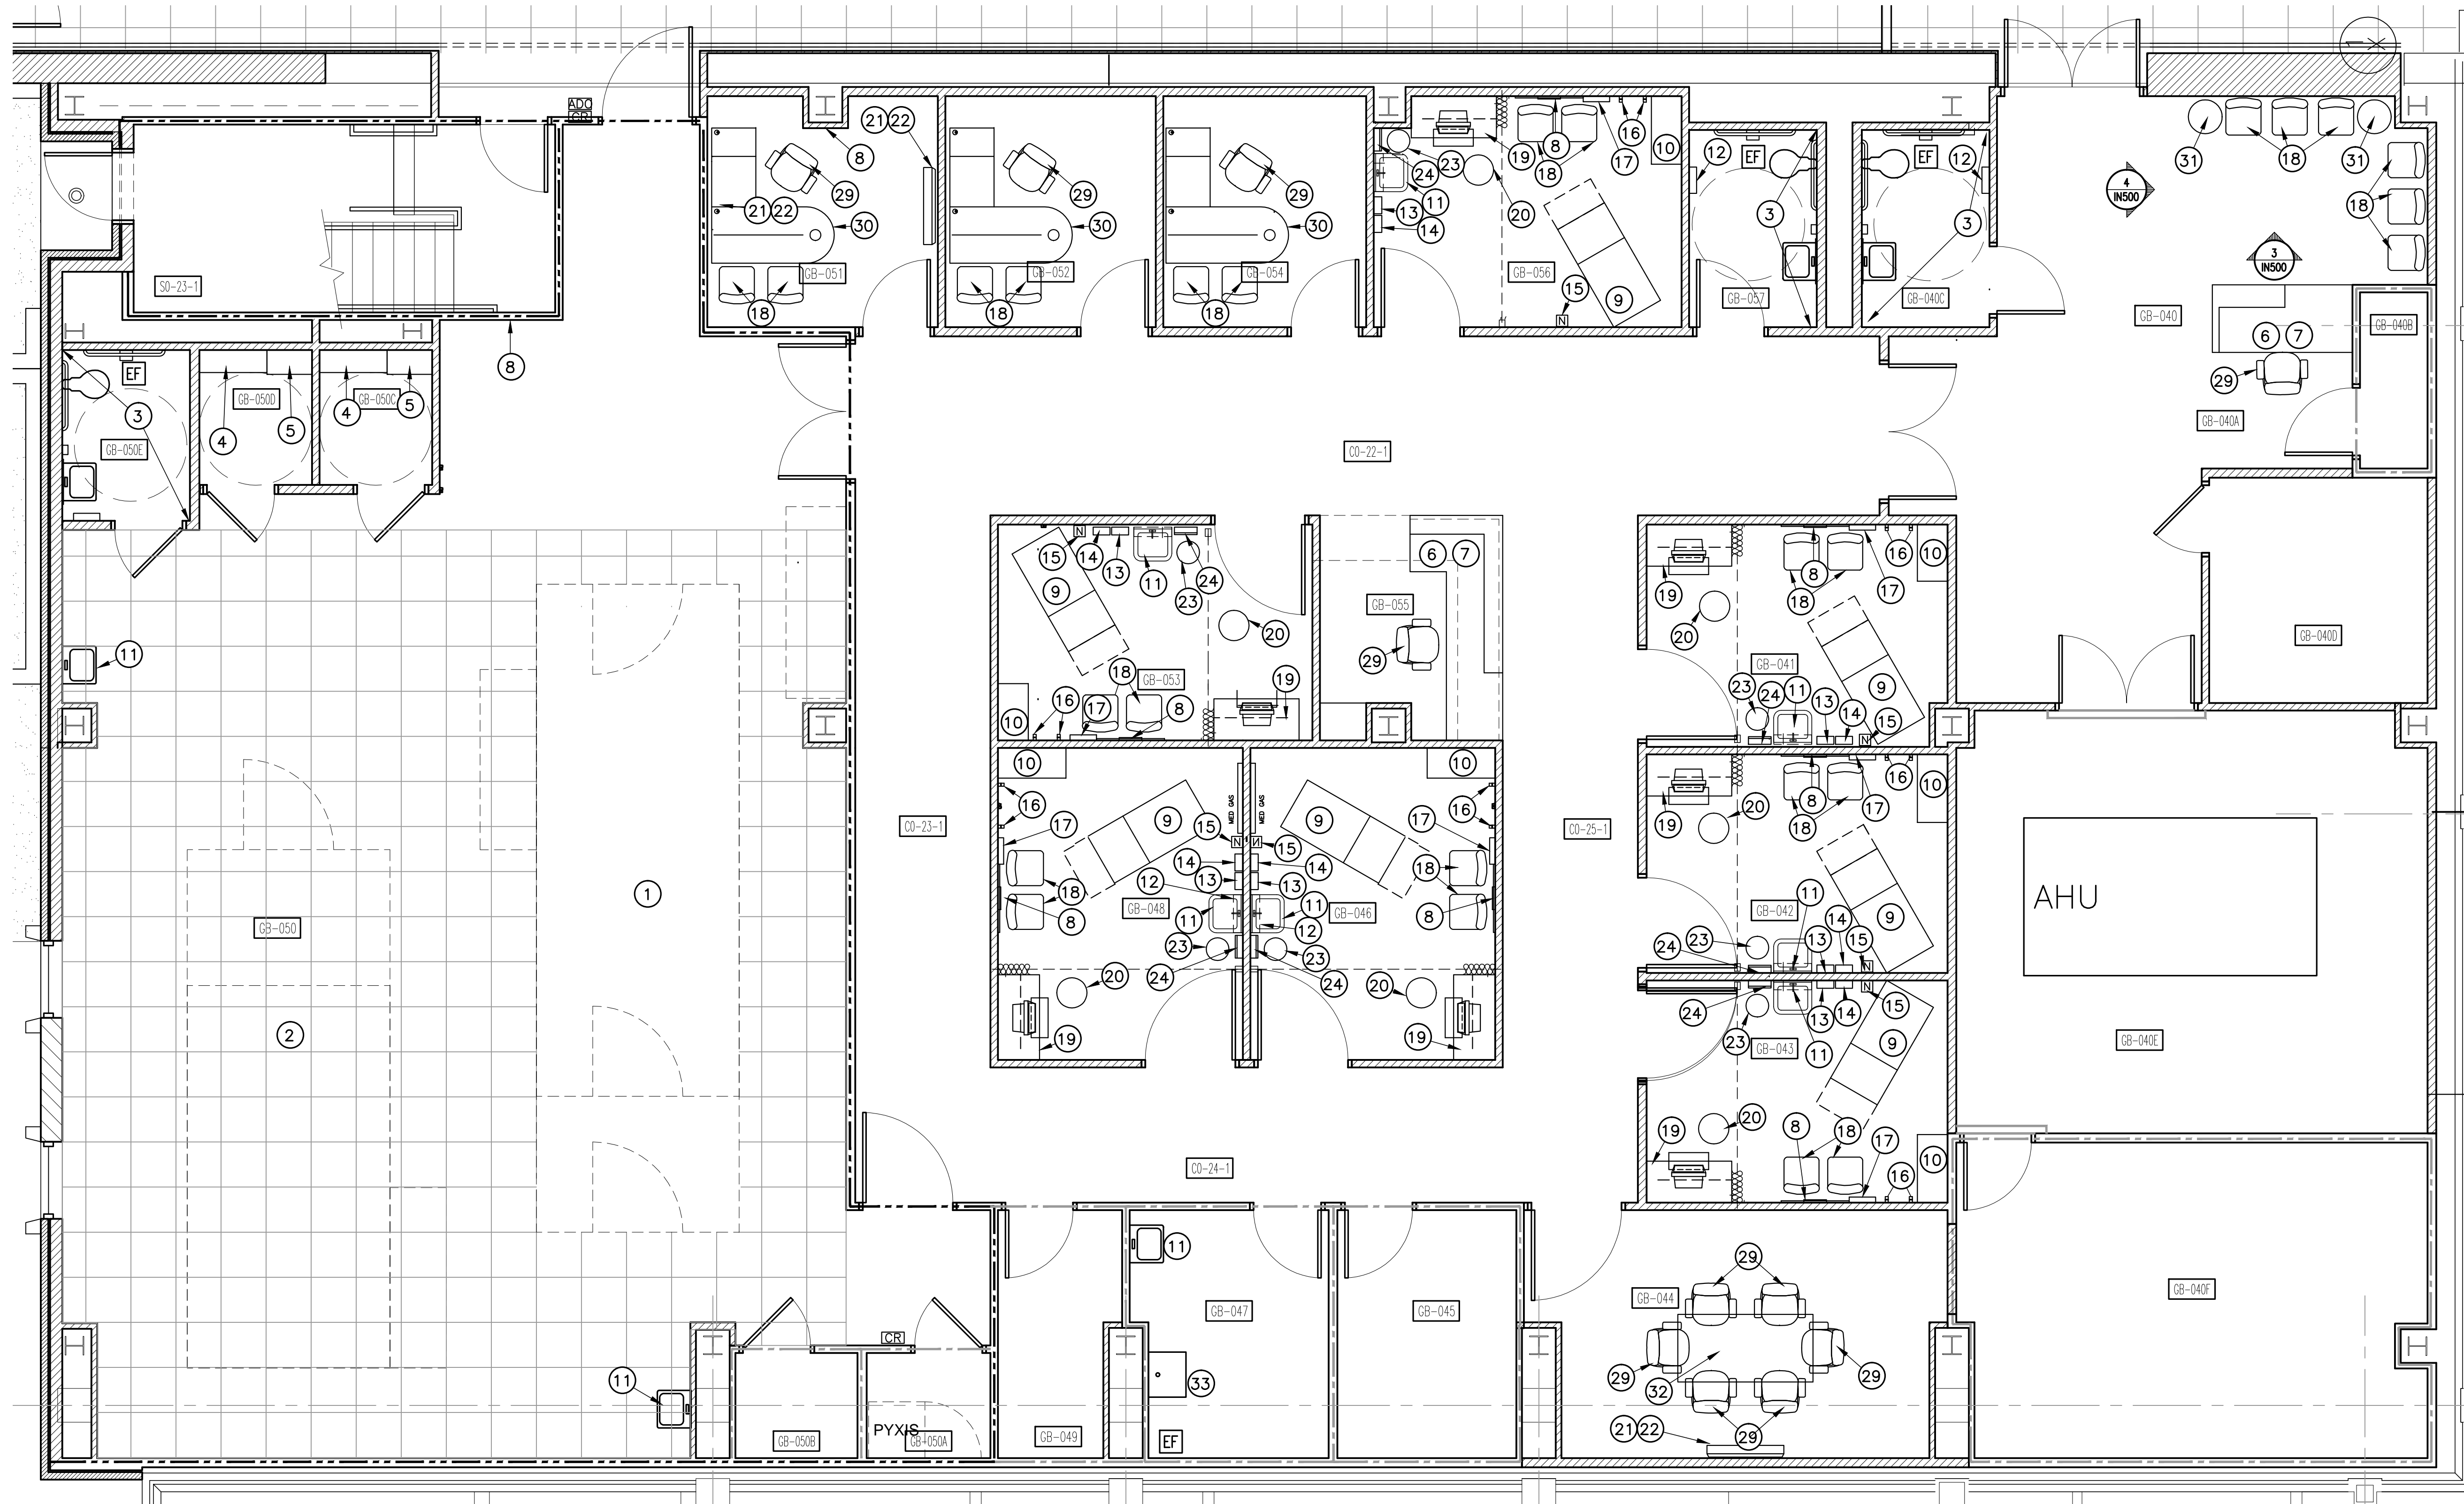

1 GROUND FLOOR -FLOOR EQUIPMENT PLAN AND FURNITURE PLAN
1/4"=1'-0"

GROUND FLOOR EQUIPMENT SCHEDULE (VERIFY W/ ACTUAL EQUIPMENT)			
ITEM #	DESCRIPTION	PROVIDED BY	INSTALLED BY
1	12 PERSON MULTIPLE HYPERBARIC CHAMBER	VA	VA
2	FUTURE MULTIPLE HYPERBARIC CHAMBER	--	--
3	RESTROOM (TOILET, SINK, GRAB BARS, & ACCESSORIES)	GC	GC
4	BENCH	GC	GC
5	PATIENT LOCKERS (4 PER ROOM)	GC	GC
6	NURSE STATION (MILLWORK)	GC	GC
7	NURSE STATION EQUIPMENT (PHONE)	VA	VA
8	WALL MOUNTED CLOCK	VA	VA
9	EXAM TABLE	VA	VA
10	INSTRUMENT CABINET	VA	GC
11	HANDSINK (SOAP, P.T. DISPENSER, HAND SANITIZER AND PAPER TOWEL DISPENSER BY VA)	GC	GC
12	STAINLESS STEEL SHELF 12"x5"	GC	GC
13	SHARPS BOX	VA	VA
14	GLOVE DISPENSER	VA	VA
15	NURSE CALL	GC	GC
16	(2) COAT HOOKS	GC	GC
17	BULLETIN BOARD/MAGAZINE RACK	VA	VA
18	CHAIR	VA	VA
19	MODULAR WORKSTATION (INCLUDING COMPUTER)	VA	VA
20	EXAM STOOL	VA	VA
21	TV WALL MOUNT	GC	GC
22	TV W/ TELCONFERENCE EQUIPMENT	VA	VA
23	WASTE RECEPTACLE	VA	VA
24	PAPER TOWEL DISPENSER	VA	VA
25	LIKORALL CEILING TRAVERSE 242 PATIENT LIFT	GC	GC
26	BURTON VISIONARY SINGLE HEAD O.R. LIGHT	GC	GC
27	CUBICLE CURTAIN	GC	GC
28	LIKORALL CEILING TRAVERSE BARIATIC PATIENT LIFT	GC	GC
29	TASK CHAIR	VA	VA
30	OFFICE TABLE UNIT	VA	VA
31	COFFEE TABLE	VA	VA
32	CONFERENCE TABLE	VA	VA
33	SERVICE SINK	GC	GC


ALL PRODUCTS LISTED ARE TO SERVE AS THE BASIS OF DESIGN.
REFER TO MANUFACTURER'S DRAWINGS FOR ADDITIONAL INFORMATION.

04-18-12 MEDICAL EQUIPMENT AND INTERIOR DESIGN REVISIONS

THE MEDICAL EQUIPMENT CONFIGURATION, LOCATIONS, TYPES, AND QUANTITIES SHOWN HEREIN ARE TO SERVE AS THE BASIS OF DESIGN. GC TO CONFIRM EXACT EQUIPMENT REQUIREMENTS WITH VA COTR

REVISION	DATE
65% SUBMITTAL	02/19/11
95% SUBMITTAL	03/29/11
100% SUBMITTAL	04/19/11
CONSTRUCTION SET	05/02/11
Clarifications to Bid Options- ADDENDUM #4	11/09/11
MEDICAL EQUIPMENT AND INTERIOR DESIGN REVISIONS	04/18/12

CONSULTANTS:









ARCHITECT/ENGINEERS:
 itv architects, inc. 11500 UNIVERSITY BLVD. JACKSONVILLE, FLORIDA 32212 P. 904.766.8333 WWW.ITVARCH.COM FL LLA00000000

Drawing Title
GROUND FLOOR EQUIPMENT PLAN
Approved Project Director

Project Title
SPECIALTY TREATMENT EXPANSION PROJECT- BUILDING #1
Location
JAMES A. HALEY VETERANS' HOSPITAL
Date
02/19/11
Checked
TTV
Drawn
TAG

Project Number
673-CSI-100
Building Number
1
Drawing Number
AS108
Dwg 12 of 40

Office of Construction and Facilities Management
 Department of Veterans Affairs

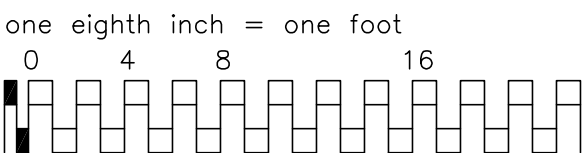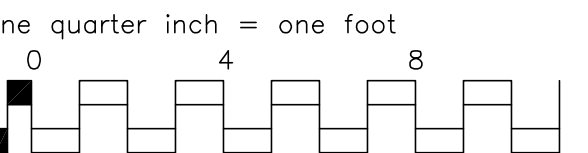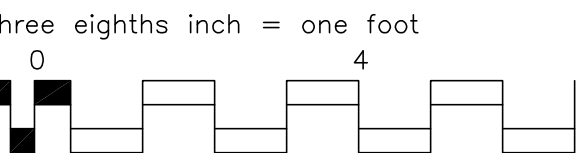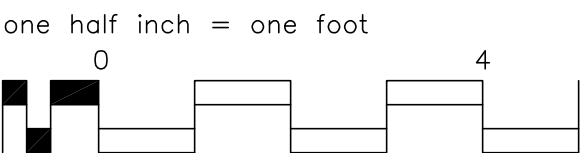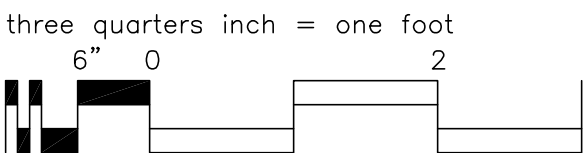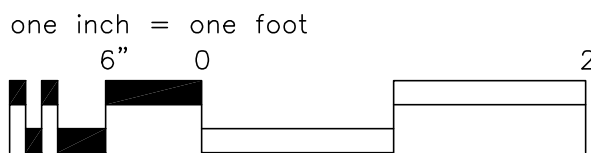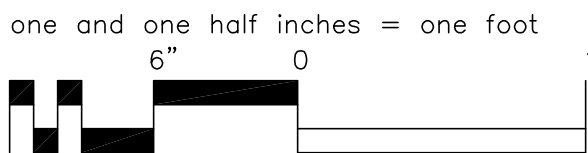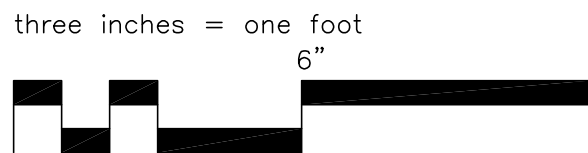


1ST FLOOR EQUIPMENT SCHEDULE (VERIFY W/ACTUAL EQUIPMENT)			
ITEM #	DESCRIPTION	PROVIDED BY	INSTALLED BY
①	PATIENT BED	VA	VA
②	PATIENT CARE MONITOR W/ SUPPORT ASSEMBLY	VA	GC
③	PATIENT CARE/EDWALL W/ OXYGEN, SUCTION, & AIRLINE	GC	GC
④	PRIVACY CURTAIN	GC	GC
⑤	T.V. MONITOR SWINGARM BY G.C. W/ TV PROVIDED BY VA	GC	GC
⑥	MOVEABLE PATIENT STORAGE UNIT	VA	VA
⑦	NURSE STATION (MILWORK)	GC	GC
⑧	NURSE STATION EQUIPMENT (PHONE)	VA	VA
⑨	WALL MOUNTED CLOCK	VA	VA
⑩	HANDSINK (SOAP, P.T. DISPENSER, HAND SANITIZER AND TOWEL DISPENSER BY VA)	GC	GC
BIRPLANE EQUIPMENT			
⑪	AXIS IMAGE SYSTEM	SIEMENS	SIEMENS
⑫	COMPUTER CONTROL WORKSTATION	SIEMENS	SIEMENS
⑬	TABLE CONTROL MODULES	SIEMENS	SIEMENS
⑭	AGE (ARCHIVE CONTROL, EXTENSION)	SIEMENS	SIEMENS
⑮	WORKSURFACE	GC	GC
⑯	DCS 6 DISPLAY CEILING SUSPENSION	SIEMENS	SIEMENS
⑰	ARTIS ZEE BIRPLANE ANCO FLOOR STAND W/ MOUNTING PLATE	SIEMENS	SIEMENS
⑱	ARTIS ZEE BIRPLANE ANCO CEILING STAND W/ LONGITUDINAL RAILS	SIEMENS	SIEMENS
⑲	PATIENT TABLE (OR)	SIEMENS	SIEMENS
⑲	UPPER BODY RADATION SHIELD 4 M TRACK	SIEMENS	SIEMENS
⑲	IMAG RAB OR LAMP	SIEMENS	SIEMENS
⑲	COOLING UNITS (2)	SIEMENS	SIEMENS
⑲	PALYODORS A100 (POWER UNIT 1)	SIEMENS	SIEMENS
⑲	POLYODORS A100 (POWER UNIT 2)	SIEMENS	SIEMENS
⑲	CABLE CABINET	SIEMENS	SIEMENS
⑲	SYSTEM CONTROL CABINET	SIEMENS	SIEMENS
⑲	SYSTEM CONTROL CABINET 2	SIEMENS	SIEMENS
⑲	SYSTEM CONTROL CABINET (OR TABLE ONLY)	SIEMENS	SIEMENS
ANGIO EQUIPMENT			
⑲	AXIS IMAGE SYSTEM W/ UPS	SIEMENS	SIEMENS
⑲	AGE (ARCHIVE CONTROL, EXTENSION)	SIEMENS	SIEMENS
⑲	COMPUTER CONTROL WORKSTATION	SIEMENS	SIEMENS
⑲	WORKSURFACE	GC	GC
⑲	TERASON ULTRASOUND INTEGRATION KIT	SIEMENS	SIEMENS
⑲	TABLE CONTROL MODULES	SIEMENS	SIEMENS
⑲	STNCO X JOYSTICK	SIEMENS	SIEMENS
⑲	DCS 4M DISPLAY CEILING SUSPENSION	SIEMENS	SIEMENS
⑲	MONITOR CART	SIEMENS	SIEMENS
⑲	ARTIS ZEE CEILING C-ARM STAND	SIEMENS	SIEMENS
⑲	PATIENT TABLE	SIEMENS	SIEMENS
⑲	UPPER BODY RADATION SHIELD 4 M TRACK	SIEMENS	SIEMENS
⑲	IMAG RAB OR LAMP	SIEMENS	SIEMENS
⑲	COOLING UNITS	SIEMENS	SIEMENS
⑲	POLYODORS A100 (POWER UNIT 1)	SIEMENS	SIEMENS
⑲	CABLE CABINET	SIEMENS	SIEMENS
⑲	SYSTEM CONTROL CABINET	SIEMENS	SIEMENS
⑲	SYSTEM CONTROL CABINET (OR TABLE ONLY)	SIEMENS	SIEMENS
⑲	MEDPAD MARK II PROXIS INJECTOR TABLE BRACKET	MEDPAD	MEDPAD
⑲	MEDPAD MARK II PROXIS INJECTOR REMOTE CONTROL	MEDPAD	MEDPAD
⑲	MEDPAD MARK II PROXIS INJECTOR ELECTRONICS BOX	MEDPAD	MEDPAD
⑲	CEILING MEDICAL GAS OUTLET	GC	GC
⑲	RESTROOM (TOILET, SINK, GRAB BARS, & ACCESSORIES)	GC	GC
⑲	TASK CHAIR	VA	VA
⑲	OFFICE TABLE UNIT	VA	VA
⑲	CHAIR	VA	VA
⑲	SERVICE SINK	GC	GC
⑲	HANGING ROD	GC	GC

REVISION	DATE
667 SUBMITTAL	02/29/11
667 SUBMITTAL	03/29/11
667 SUBMITTAL	04/19/11
1007 SUBMITTAL	05/02/11
CONSTRUCTION SET	11/09/11
△/△ Modifications to BID Option - ADDENDUM #4	04/18/12
MEDICAL EQUIPMENT AND INTERIOR DESIGN REVISIONS	

ALL PRODUCTS LISTED ARE TO SERVE AS THE BASIS OF DESIGN.
REFER TO MANUFACTURER'S DRAWINGS FOR ADDITIONAL INFORMATION.

CONSULTANTS

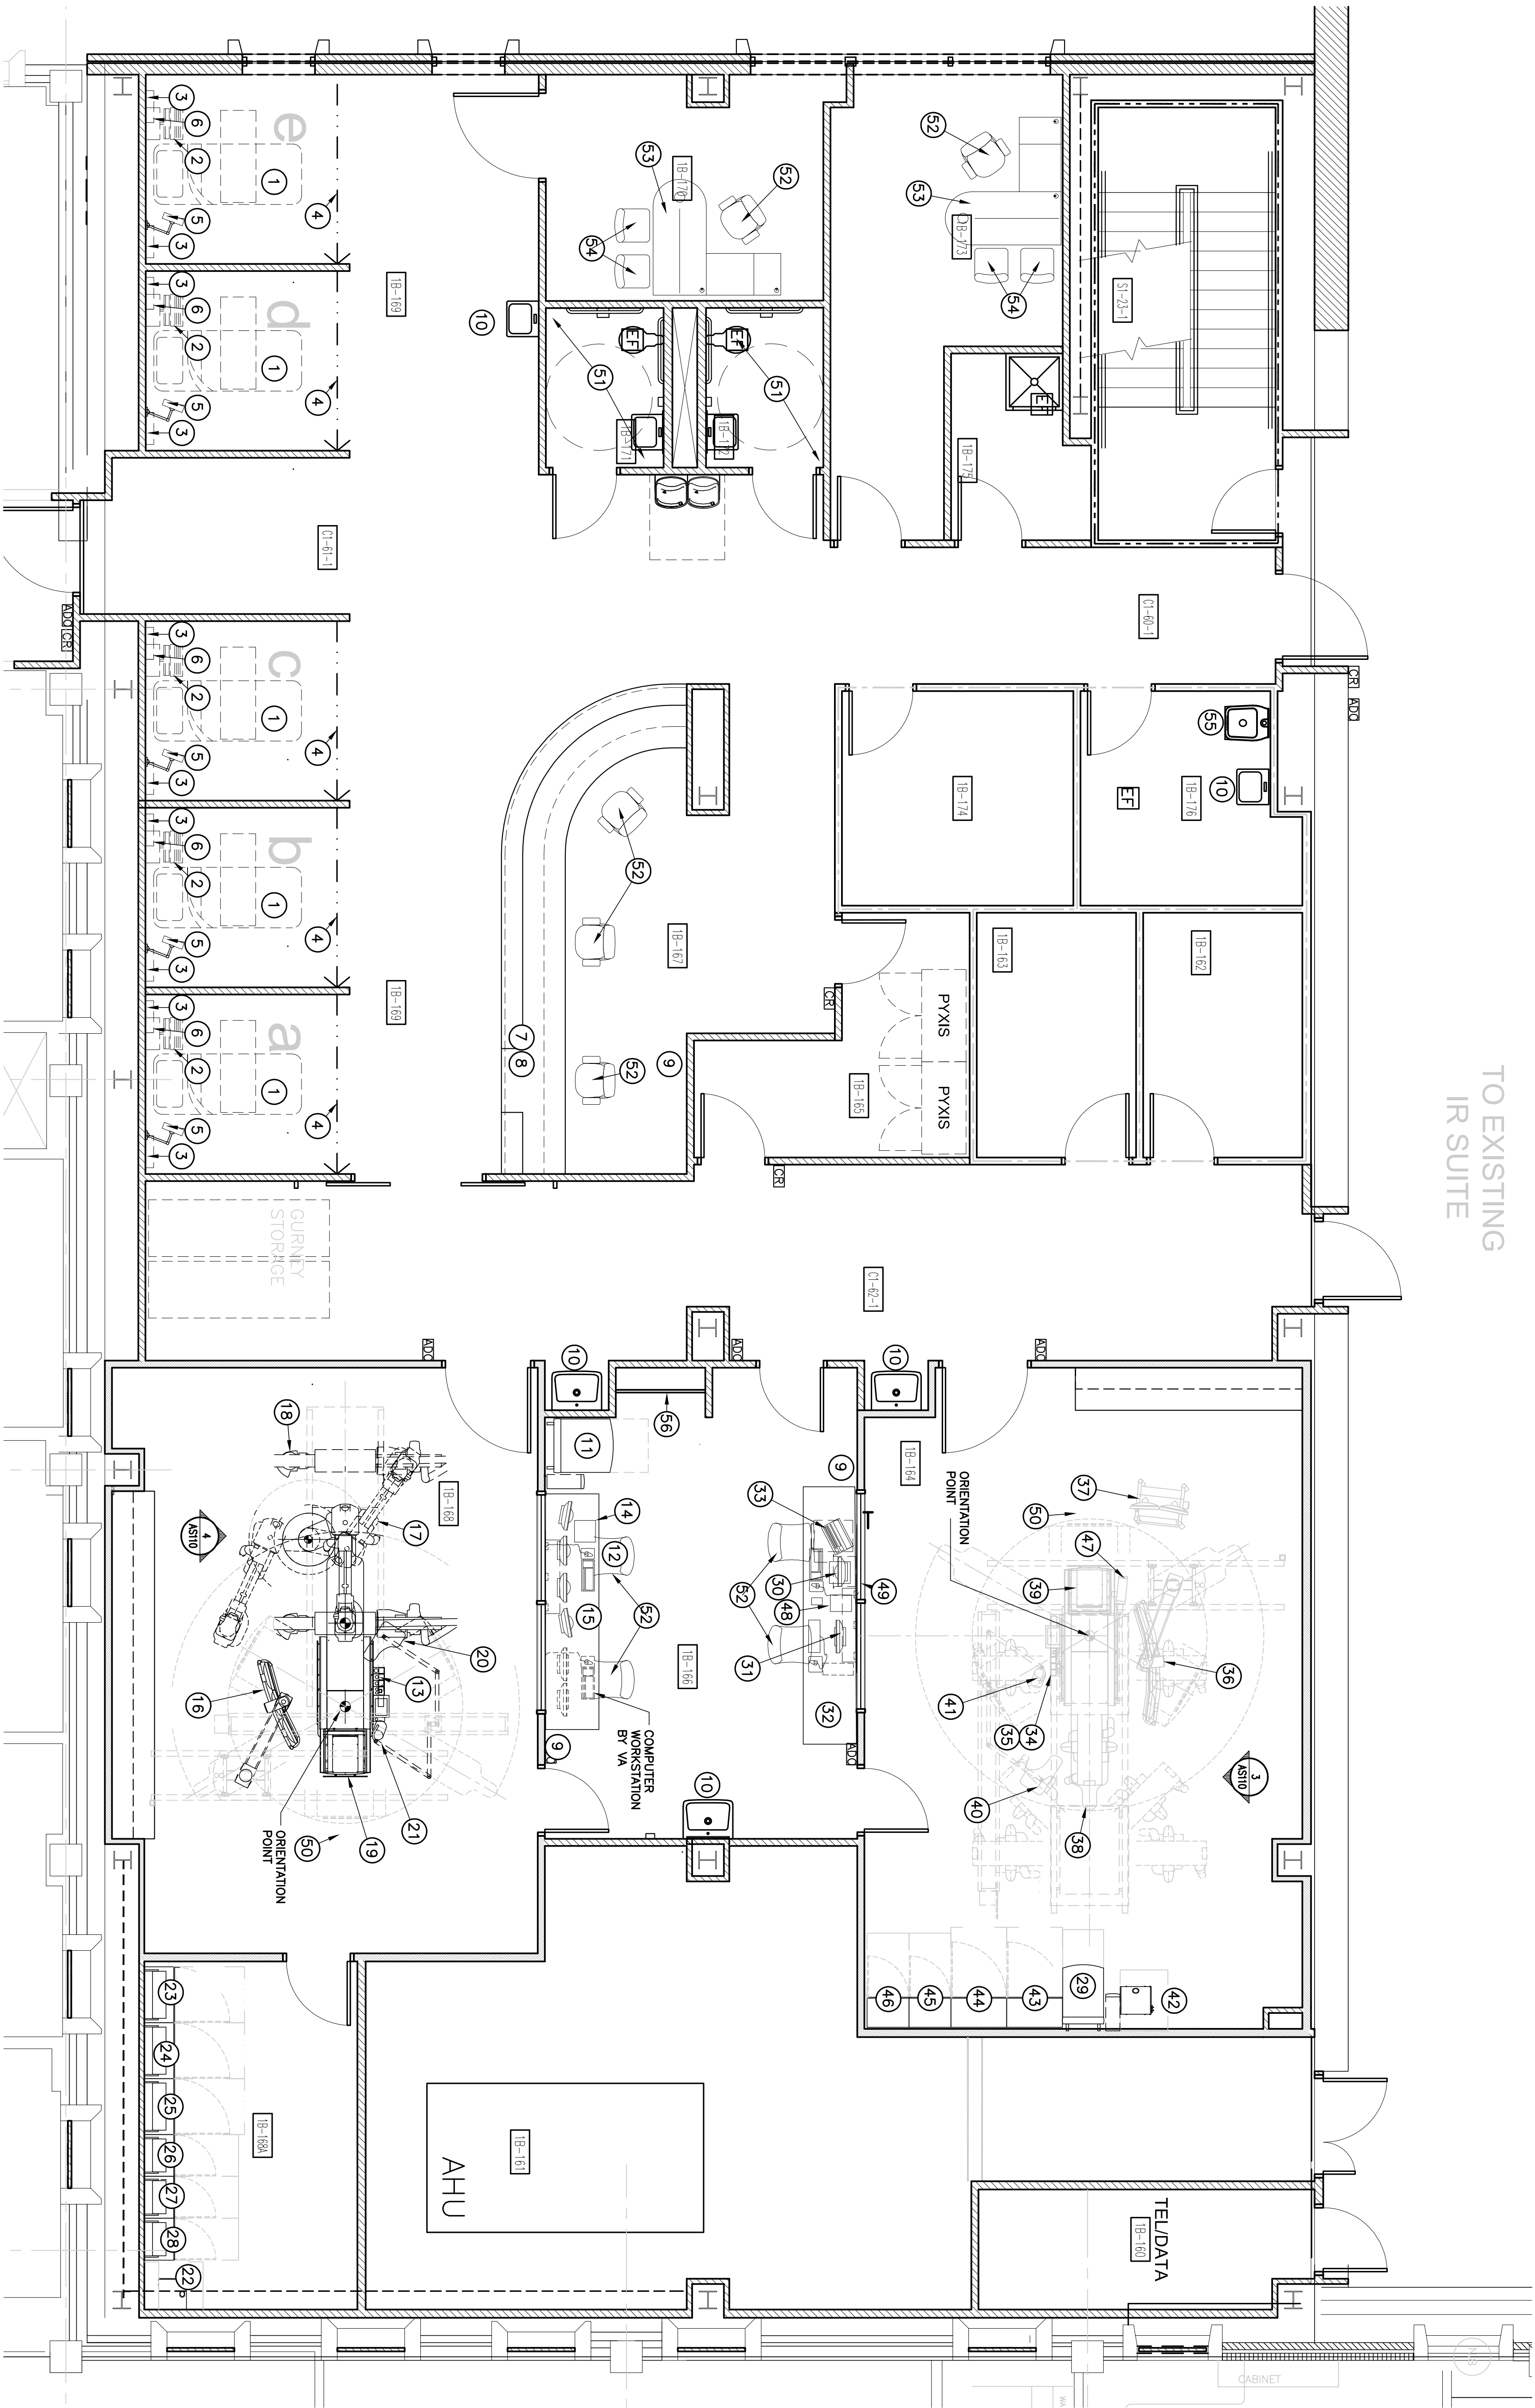

TELEVISION MONITOR SWINGARM: EQUAL TO PD-508C-7PIL
SWINGARM AS MANUFACTURED BY PDI COMMUNICATION
SYSTEMS. PROVIDE BACKING, ANCHORAGE, & ALL COMPONENTS
AS REQUIRED FOR RIGID & COMPLETE INSTALLATION

04-18-12 MEDICAL EQUIPMENT AND INTERIOR DESIGN REVISIONS

THE MEDICAL EQUIPMENT CONFIGURATION, LOCATIONS, TYPES, AND QUANTITIES SHOWN HEREIN ARE TO SERVE AS THE BASIS OF DESIGN. GC TO CONFIRM EXACT EQUIPMENT REQUIREMENTS WITH VA COTR

ARCHITECT/ENGINEERS:



1115 EAST FOREST ST
MCDONVILLE, NC 28654 2222
T 904.783.8333
F 664.796.8335
WWW.DJBOOTH.COM
FL 115-0A0000000

Drawing Title
1ST FLOOR EQUIPMENT PLAN

Project Title
SPECIALTY TREATMENT EXPANSION
PROJECT- BUILDING #1

Project Number
673-CSI-100

Approved: Project Director

JAMES A. HALLEY VETERANS' HOSPITAL

Date	Checked	Drawn
02/19/11	TTV	TAG

Checked	Drawn
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Drawn

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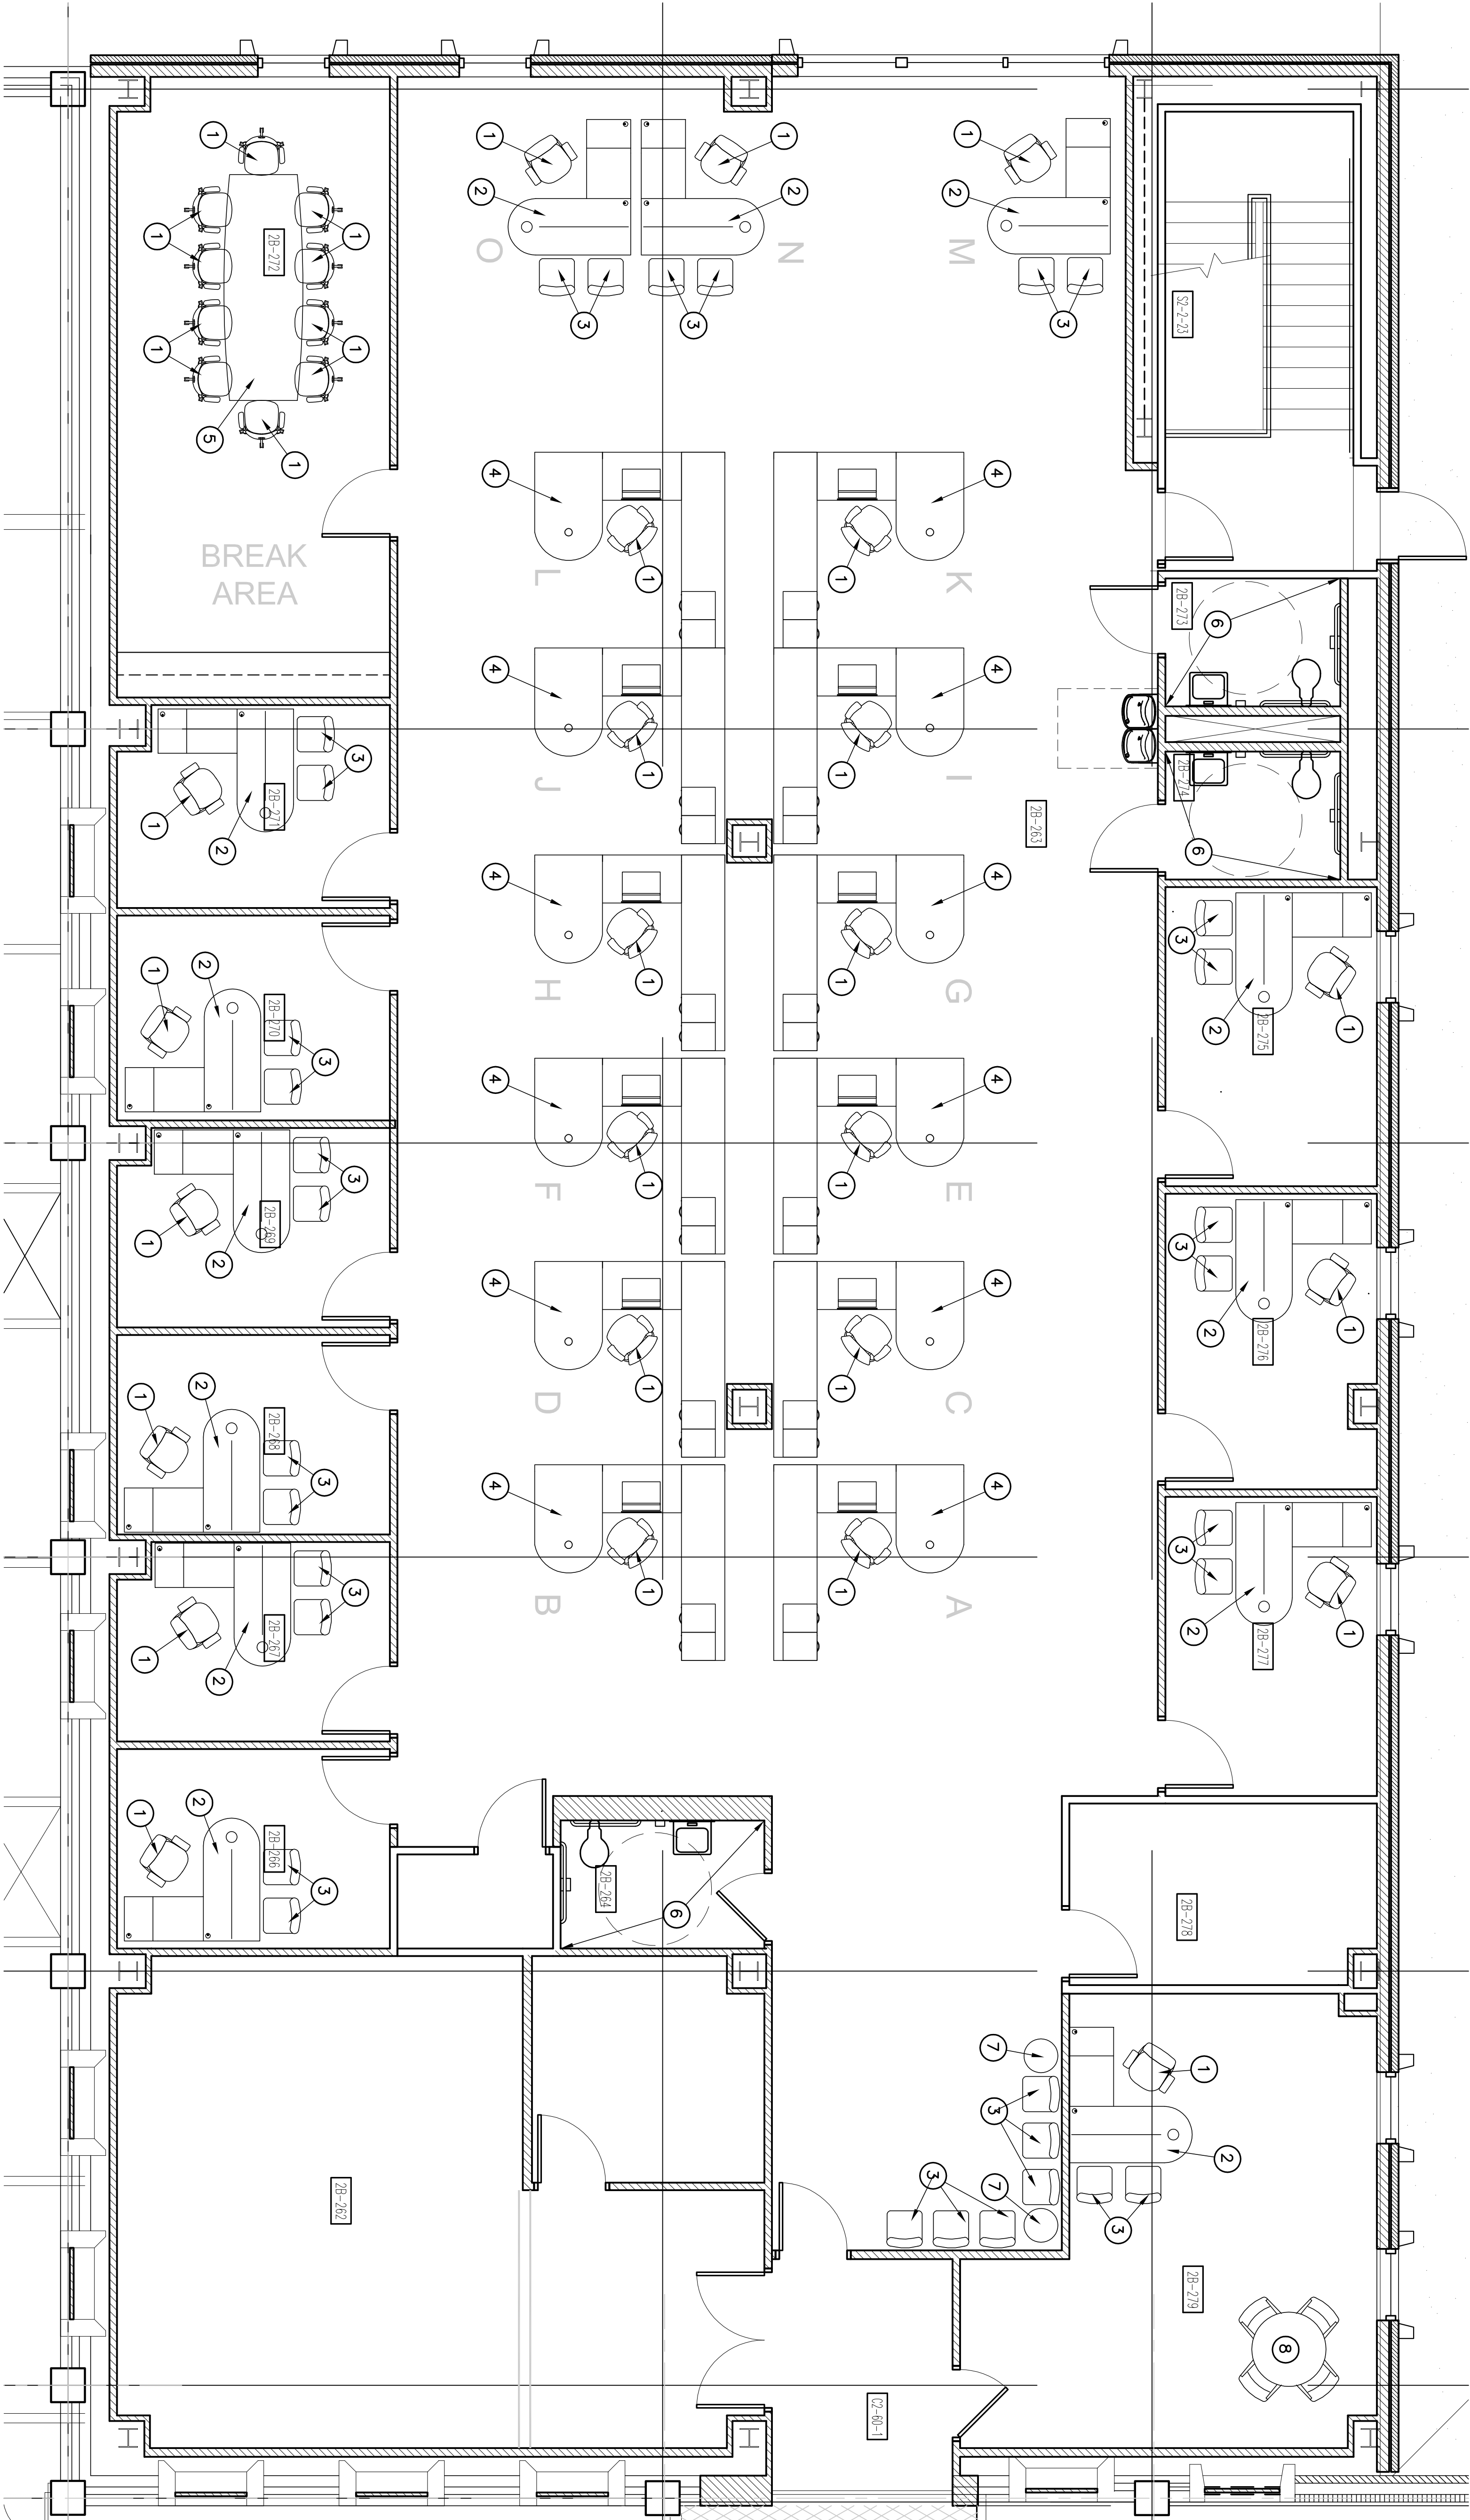
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**Office of
Construction
and Facilities
Management**



2ST FLOOR EQUIPMENT SCHEDULE (VERIFY W/ACTUAL EQUIPMENT)		
ITEM #	DESCRIPTION	PROVIDED BY
1	TASK CHAIR	VA
2	OFFICE TABLE UNIT	VA
3	CHAIR	VA
4	CUBICLE TABLE UNIT	VA
5	CONFERENCE TABLE	VA
6	RESTROOM (TOILET, SINK, GRAB BARS, & ACCESSORIES)	GC
7	COFFEE TABLE	VA
8	ROUND DINING TABLE WITH 4 CHAIRS	VA

ALL PRODUCTS LISTED ARE TO SERVE AS THE BASIS OF DESIGN.
REFER TO MANUFACTURERS DRAWINGS FOR ADDITIONAL INFORMATION



N
1 2ND FLOOR -FLOOR EQUIPMENT PLAN
1/4"=1'-0"

REVISION	DATE
602 SUBMITTAL	02/19/11
602 SUBMITTAL	02/29/11
602 SUBMITTAL	04/05/11
CONSTRUCTION SET	06/02/11
1/ Corrections to Bid Options - ADDENDUM #4	11/09/11
MEDICAL EQUIPMENT AND INTERIOR DESIGN REVISIONS	04/18/12

CONSULTANTS:

ARCHITECT/ENGINEERS:



iiv architects, inc.
ARCHITECTS/ENGINEERS
2000 N. 10TH STREET
SUITE 200
DENVER, CO 80202
P: 303.733.8800
F: 303.733.8800

04-18-12 MEDICAL EQUIPMENT AND INTERIOR DESIGN REVISIONS

Drawing Title		Project Title		Project Number	
2ND FLOOR EQUIPMENT PLAN		SPECIALTY TREATMENT EXPANSION PROJECT - BUILDING #1		673-CS1-100 Building Number	
Approved Project Director		Location		Drawing Number	
		JAMES A. HALEY VETERANS HOSPITAL		1	
Date	02/19/11	Checked	TTV	Drawn	TAG
				AS110	
				Dwg. 14 of 40	



Department of
Veterans Affairs

Office of
Construction
and Facilities
Management